Midlothian ISD Campuses Safety and Security Upgrades



CONSULTANT INFO

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19569 06/02/2021

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Security Upgrades

Safety 6

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OWP PROJECT NO. DATE OF ISSUE 2021_097 06.02.2021

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REVISIONS


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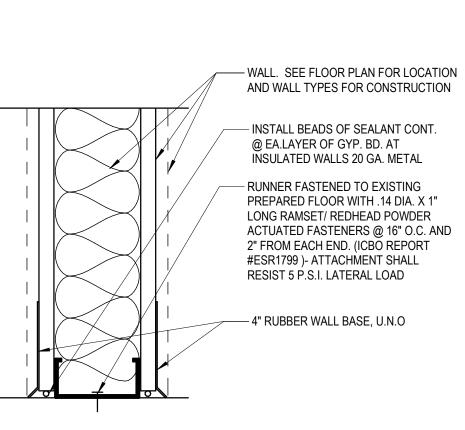
PROJECT PHASE

Construction Documents

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TITLE SHEET




WALL AT CEILING 4 IN. ABOVE

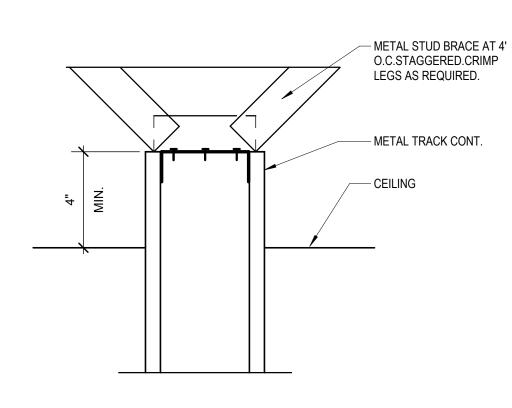

BASE AT STUD WALL

CONDITION 6

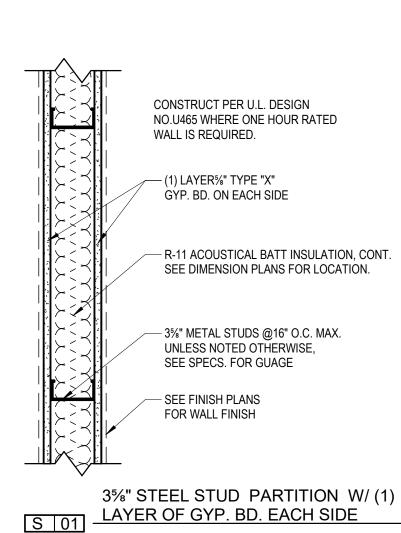

SECTION 02 4100 Visit site and examine the existing Work area.

B. Execute demolition Work in an orderly and careful manner with consideration for existing structures, including parts of the surrounding areas that are to remain. Protect existing active service lines whether indicated or not. Provide "walk-off mats" or other protection at entry to work area. Keep corridors clean and clear. C. Use movable, covered debris boxes to convey the material through the building. Do not store

or permit debris to accumulate on the site. D. Remove, protect and turn over to the Owner items noted to be salvaged. If item is to be used elsewhere on this project store and protect per section 01 6000, Product Requirements. E. Throughout construction, remove excess materials, equipment and debris and dispose of

away from premises. F. If hazardous materials are encountered the Contractor shall notify the Owner before proceeding with work in the affected area.

SECTION 07 2100 THERMAL INSULATION / SOUND ATTENUATION A. Manufacturers

2. Johns-Manville Knauf

CertainTeed

- 4. Owens Corning B. Materials
- 1. Sound Attenuation Batts: formaldehyde-free (full thickness of stud cavity) in all walls enclosing occupied rooms. 2. Fiberglass Batt Insulation: exterior walls shall be insulated with formaldehyde-free unfaced batt insulation having a thermal resistance value of R-19 U.N.O. All uninsulated roof assemblies shall be insulated with batt insulation having a thermal resistance value of R-30 U.N.O. and be covered by a continuous convection barrier. Batt insulation shall comply with ASTM C665 Type 1, and C518, ASTM C 1304 (Odor Emission) and ASTM C 1338 (Fungi Resistance).
- Installation 1. Install sound attenuation batts over ceilings 2'-0" each side of all sound attenuated partitions where partition does not extend to deck. Batts in exterior walls shall be installed tight against framing members with no gaps or

SECTION 07 9200 JOINT SEALANTS A. Manufacturers

- Dow Corning Pecora Sika
- Sonneborn Tremko
- 1. Sealant: The type and grade as recommended by the manufacturer for the service intended and surfaces to be sealed. Back-up materials: Compatible with sealant and primer, and of a resilient nature.
- 3. Bond Breaker: Pressure sensitive tape recommended by sealant manufacturer to suit application.
- Install caulk/sealants at all intersections of dissimilar materials required for appearance or to stop passage of air, noise, or light or moisture and as recommended by the
- 2. Install back-up material or joint filler, of type and size to provide sealant dimensions recommended by manufacturer. Do not apply sealant to joints over 3/16" without back-
- Sealant color shall match the color of the material sealed, unless otherwise noted. Approval of color shall be obtained prior to application. Provide sealant at the following locations 5. Plumbing fixtures to abutting material - One-part silicone rubber sealant with fungicide.
- 6. Perimeter of exterior door frames, both sides Two-part, gun grade, non-sag, 7. Perimeter of any window units, both sides - Two-part, gun grade, non-sag, polyurethane
- 8. Perimeter of exterior grilles/louvers Two-part, gun grade, non-sag, polyurethane
- 9. Masonry at dissimilar material Two-part, gun grade, non-sag, polyurethane sealant. 10. At stud wall base plates and around electrical outlets and penetrations at acoustically rated walls - One-part, gun grade, synthetic rubber, suitable for non-exposed locations. 11. Expansion and control joints at walks, plazas and at pavements abutting building face -

Two-part self-leveling type sealant for horizontal joints subjected to traffic.

- NON-STRUCTURAL METAL FRAMING
- . CEMCO Clark Dietrich Building Systems MarinoWAREMBA Building Supplies
- SCAFCO United Metal Products
- Materials Studs, Track and Furring

SECTION 09 2216

Manufacturers

- Roll formed 20 or 25 gauge electrogalvanized steel, sizes indicated, conforming to ASTM C645. b. Use 20 gauge for door jambs and walls to receive ceramic tile or cement backer
- board and for walls over 14 feet high. Provide slotted track at top of partitions subject to deflection.
- Top track to be slotted and designed to accommodate the specified studs. e. Fire and sound rated construction: Provide studs, track and furring in accordance
- with assemblies specified or noted on Drawings. Suspended Ceiling Components a. Furring channels: Type DWC as manufactured by U.S. Gypsum Company, or rigid
- furring channels conforming to ASTM C645, 2-5/8 inches wide by 7/8 inch by 0.0188 b. Main runner channels: Cold rolled sections, 1-1/2 inches, formed of No. 16 gauge
- Hanger wires: 8 gauge.
- Brackets: 20 gauge. e. Tie Wire: 18 gauge galvanized.
- Install cold-formed framing in accordance with requirements of current versions of ASTM C754, AISD-WSD AISI-NAS, AISI-WSD, AISI-Header and the current Gypsum Construction Handbook and relevant sections of the IBC. System design shall resist horizontal loads (regular and seismic) as required by IBC and local AHJ. In addition, comply with the following requirements.
- a. At doors wider than 36" and at all lead-lined doors, provide diagonal bracing of wall above door in both directions at 6" above ceiling line. b. Isolate studs at exterior masonry or concrete wall surfaces, with closed cell form
- c. One pair of 16 gauge structural steel studs shall be installed, running from floor to structure above, at each location to receive wall mounted television, shelving,
- brackets, etc. supporting loads greater than 25 pounds. Brace tops of walls that do not extend to deck at 4' o.c. in alternate directions. e. Provide 18 gauge metal backing for attachment of all wall mounted items. Backing shall be a minimum of 6" wide and shall extend over a minimum of 2 studs.
- f. Bridge stud partitions at mid-height for partitions 10 feet high or less, and at 5 feet on center for partitions greater than 10 feet, with 1-1/2 inch channels through studs g. At walls that do not extend full height and are not otherwise braced, provide and
- install 2-1/2" x 2-1/2" x 3/16" tube steel stiffeners welded to base plate and anchored to floor with four (4) 1/2" x 2-1/2" expansion anchors. Set stiffeners at 4'-0" O.C. and secure to continuous 20 gauge top track.
- Suspended ceilings shall be constructed with 1-1/2 inch main runner channels spaced 4' oc and metal furring channels spaced on not over 16 inch centers. Locate main runner within 6 inches of the wall to support the ends of the furring channels and locate hangers to support the ends of the main runners. Suspend main runners from structure above with one hanger wire for each 12 square feet of ceiling area. Hanger spacing shall not exceed 48 inches on center along channel and shall occur within 6 inches of end of channels. Provide additional support for lights, grilles and other items that attach to or project through ceiling.

SECTION 09 2900 **GYPSUM BOARD** . Manufacturers

- Certainteed CertainTeed Corporation Georgia Pacific Gold Bond Building Products
- National Gypsum Company Pabco Gypsum
- United States Gypsum
- Materials
- Gypsum Board: 5/8 inch thick, Type X, Gypsum board shall conform to applicable sections of ASTM C1396, ASTM C1629 Gypsum board core material to provide "VOC
- Water Resistant Gypsum Board: Use fiberglass faced water resistant type wallboard in toilet rooms, kitchens (within 4 feet of sinks), and other high moisture areas and where indicated on Drawings.
- Cementitious backer board: In wet areas use 1/2" fiberglass reinforced cement backer board under ceramic tile. Lead-Faced Gypsum Board: Where indicated on Drawings. Continuous lead sheet
- laminated to face of core. Thickness of lead to be as specified on physicist's report. Shaftwall Coreboard: 1" thick or as indicated on assembly detail.
- Impact-Resistant Gypsum Board: Where indicated on Drawings Noise Reduction Gypsum Board: Where indicated on Drawings
- Trim and Edging: 26 gauge, electro-galvanized steel
- 1. Comply with GA-216: Specifications for the Application and Finishing of Gypsum
- Wherever gypsum board terminates against dissimilar materials, install metal edge ("J" trim or similar).
- Finish to comply with ASTM C840 Specification for Application and Finishing of Gypsum Board and GA-214: Recommended Levels of Gypsum Board Finish.
- "Level 4" finish to be provided at all locations U.N.O. on plans.

PAINTING AND COATING SECTION 09 9100 . Manufacturers

- Benjamin Moore Paints Sherwin Williams
- Materials Water-based, Low Odor products from manufacturer's top of the line products.
- Refer to the "Finish Plan" on the Drawing for designated finishes. Provide 3 samples paint "draw-downs" for each color and sheen scheduled. The following are acceptable products of Sherwin Williams. Other manufacturers

indicated in this section or by prior approval shall furnish equal types of materials. Responsibility for recommending, scheduling and using the proper paint for the job conditions rests with the manufacturer and Contractor.

1st Coat: ProMar 200 Zero VOC Interior Latex Primer B28W2600, MPI #149 2nd Coat: ProMar 200 HP Zero VOC Interior Acrylic Low Gloss Eg-Shel B41-1900 Series 3rd Coat: ProMar 200 HP Zero VOC Interior Acrylic Low Gloss Eg-Shel B41-1900 Series (Gloss Level 3) MPI # 144 X-Green

1. The number of coats scheduled is the minimum number of coats required. Additional coat(s) shall be applied, at no additional cost to the Owner, to completely hide base material, provide uniform color and to produce satisfactory finish results.

Exposed water, gas, waste piping, sprinkler piping, conduit, lighting and electrical panels, telephone terminal boxes, galvanized ducts and insulated ducts, shall be painted in areas other than mechanical rooms, unless otherwise scheduled. Paint exposed unfinished fixtures, metal ducts, switch boxes, control panels, devices, starters, junction boxes, vents, drains, and other similar items, as directed by Architect. Fire hose cabinets, access panels (except stainless steel), air registers and grilles,

electrical panelboards, primed hardware, and other similar items, shall be painted to match adjacent surfaces, at the direction of the Architect, even though the item already may have a factory applied finish. After taping and sanding gypsum board but prior to texturing, apply one coat of 1030 Ultra-Hide PVA Interior Primer-Sealer to gypsum board surfaces. The primer-sealant coat shall contrast with the color of the texture material. This primer-sealer coat may be deleted at gypsum board surfaces that receive a 100 percent skim coat of texture before

suspended space heaters, flanges around ceiling fixtures, exposed pipe and conduit,

WALL & PARTITION GENERAL NOTES

on-site. The drawings shall be specific for each penetration type.

exterior walls, the floor below and the floor or ceiling above.

Specifications for Installation of Steel Framing Members".

of the structure above.

F. Brace interior non-bearing walls to structure per Architectural Drawings.

A. All fire rated walls shall be completely and continuously constructed first, and then other non-rated walls constructed to the finished surface.

only UL or ICC-ES approved methods, materials and installation, as required to maintain the

drawing details, furnished by the manufacturer of the fire stop material, that show complete

D. Smoke separation walls shall form an effective membrane, continuous from outside wall to outside

completely seal all openings where the smoke barrier abuts other smoke barriers, fire barriers,

G. Slotted slip track shall be used at all top of full-height wall conditions subject to loading by deflection

H. All light gauge metal framing shall be installed in strict accordance with ASTM 754 "Standard

E. All backing support for wall mounted items shall be 16 gauge min. metal strapping, UNO.

assembly's rating and smoke resistance. All materials and installation details shall conform to the UL

listings for "through penetration fire stop systems" where applicable. The Contractor shall submit shop

conformance to the UL Listing, and such drawings shall be available to the Fire or Building Inspectors

wall, from fire barrier to fire barrier, from smoke barrier to smoke barrier and from floor slab to floor or roof slab above, thereby providing continuity through all concealed spaces. The Contractor shall

- B. Typical details may not be necessarily be cut on plans, but apply unless noted B. All fire rated walls extend full height to structure above and seal to deck, UNO. See Fire Rated Details for approved joint conditions.
- C. All work and material shall be regarded as new unless specifically indicated as "existing" or "(e)" on the drawings and/or within the specifications. C. All penetrations at smoke and fire rated assemblies shall be protected, sealed, and dampered, using

PROJECT GENERAL NOTES

D. Contractor shall coordinate all trades and methods of construction as required

A. Do not scale drawings. Rely only on Architect's written dimensions.

- for completion of the project with the intent of these documents.
- E. All materials and unfinished surfaces exposed to view shall be painted unless factory prefinished, noted otherwise, or directed by the Architect.
- F. No utilities, plumbing, piping, conduit, etc. shall be exposed without the written approval of the Architect.
- G. Should dimensions be missing or conflicting, notify the Architect prior to proceeding with related work.
- H. Contractor shall verify locations of utilities prior to excavating, trenching, etc. and shall repair or replace utilities damaged as a result of construction.
- I. Contractor shall be responsible for all temporary shoring and bracing required during construction.
- J. Security and safety are the Contractor's responsibility. Site shall be completely fenced and secured during construction. K. No asbestos shall be used or incorporated into the project in any form.
- L. Separate dissimilar metals as they occur and/or per manufacturer's recommendations.
- M. Apply sealant at intersections of all dissimilar materials

ABBREVIATIONS LIST

AB ABC A/C ACT AFF ALT ALUM	Anchor Bolt Aggregate Base Course Air Conditioning/Conditioner Acoustical Ceiling Tile Above Finish Floor Alternate Aluminum	MAS. MAX MECH MFR MO MIN MISC MTL.	Masonry Maximum Mechanical Manufacturer Masonry Opening Minimum Miscellaneous Metal
BRG. BUR BM	Bearing Built up roof Beam	NIC NTS	Not In Contract Not To Scale
CI CJ CL CLG CLR	Cast Iron Control Joint Center Line Ceiling Clear	OC OD OPP. ORD	On Center Outside Diameter Opposite Overflow Roof Drain
CMU CO COL CONC CONT CPT	Concrete Masonry Unit Clean Out Column Concrete Continuous Carpet	PL PLAM PLMB. PLYWD. PWR	Property Line Plastic Laminate Plumbing Plywood Power
CT	Ceramic Tile	RD RO	Roof Drain Rough Opening
DF DIA DIM DS DWG	Drinking Fountain Diameter Dimension Downspout Drawing	SCHED SF SHT SIM.	Schedule Square Foot Sheet Similar
EDF ELEC EJ EL EQ EXIST EXT	Electric Drinking Fountain Electrical Expansion Joint Elevation Equal Existing Exterior	SLV SPEC. SQ STD STRL S/S SS SUSP.	Short Leg Vertical Specifications Square Standard Structural Stainless Steel Sanitary Sewer Suspended
FBO FD FDC FEC FF FG FIN FLR.	Furnished By Owner Floor Drain Fire Department Connection Fire Extinguisher Cabinet Finished Floor Finished Grade Finish Floor	T &G TEMP. TLT TOJ TOB TOC TOM TOP	Tongue and Groove Tempered Toilet Top of Joist Top of Beam Top of Curb/Conc. Top of Masonry Top of Plate
GA GAL. GLB GWB GYP	Gauge Galvanized Glue Laminated Beam Gypsum Wall Board Gypsum	TOS TOW TYP. UG UNO	Top of Steel Top of Wall Typical Underground Unless Noted Otherwis
HB HM	Hose Bibb Hollow Metal	VCT VERT.	Vinyl Composition Tile Vertical
HORIZ HVAC ID INFO INT	Horizontal Heating/Ventilating/Air Conditioning Inside Diameter Information Interior	WC WD WH WWF	Water Closet Wood Water Heater Welded Wire Fabric

LAV Lavatory
LLG Long Leg Vertical
LVR Louver

TYPICAL SYMBOLS LEGEND NORTH ARROW **EXTERIOR ELEVATION** (A101) INTERIOR ELEVATION NUMBER DOOR TAG - DOOR RATING(MIN.) KEYNOTE - WALL TYPE NUMBER

MATERIALS LEGEND

ROOM NAME & NUMBER

WALL TAG

WINDOW TAG

NOTE: PATTERNS SHOWN REPRESENT CUT MATERIALS IN PLAN OR SECTION, UNLESS NOTED OTHERWISE ABOVE.

AS NOTED

BRICK MASONRY

MARBLE OR AS NOTED TERRA COTTA, STRUCTURAL CLAY

FINISHED WOOD

ENGINEERED WOOD: GLUE WOOD FLOOR, WOOD SHINGLES,

OR SIDING PARTICLEBOARD PLYWOOD

SPRAYED FIREPROOFING SHOWN ON ROLLED SHAPE

BATT INSULATION: THERMAL OR ACOUSTICAL, UNO RIGID INSULATION: THERMAL, ACOUSTICAL, OR SAFING

DAMPPROOFING

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ANE OF TE

06/02/2021

ROOM NAME

GRANULAR FILL

CAST-IN-PLACE CONCRETE

PRECAST CONCRETE, CAST STONE CONCRETE MASONRY UNIT

STONE: LIMESTONE, GRANITE,

METAL: TYPE AS NOTED

METAL: ROLLED SHAPES

SHOWN CUT AND ELEVATION

GLASS FIBER REINFORCED CONCRETE SIDING OR TRIM

ACOUSTICAL CEILING TILE WOOD FRAMING / BLOCKING: CONTINUOUS

MEMBRANE: WATERPROOF, ROOF,

SHEATHING: GYPSUM, OR AS NOTED

AIR BARRIER SYSTEM

06.02.2021 REVISIONS

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OWP PROJECT NO. DATE OF ISSUE

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Midlothian, TX 76065

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PROJECT TEAM DRAWN BY TX Ed Studio

PROJECT PHASE Construction Documents

SHEET CONTENTS PROJECT INFORMATION

SHEET NO.

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PROJECT PHASE Construction Documents

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ADA DETAILS

SHEET NO. G-011

L.A. MILLS MIDLOTHIAN ADMINISTRATION BUILDING 100 WALTERS STEPHENSON RD. MIDLOTHIAN, TX 76065

DEMOLITION LEGEND EXISTING WALLS, STRUCTURE, WINDOWS, ETC. TO REMAIN EXISTING WALL TO BE REMOVED

EXISTING DOOR & FRAME TO BE

LINE OF EXISTING WALK, STAIR, FIXTURE OR OTHER SIMILAR ITEM TO BE REMOVED. EXISTING WINDOW TO BE REMOVED

SHADING INDICATES AREAS WHERE FINISHES ARE TO BE REMOVED. SEE KEYNOTES FOR FURTHER ADDITIONAL INFORMATION. FINISHES INCLUDE ALL FLOOR COVERING, BASE, WALL COVERING, CEILINGS, ETC. COORD. W/ MECHANICAL, ELECTRICAL & PLUMBING

DEMO FLOOR PLAN - L.A. MILLS ADMINISTRATION BLDG

DEMOLITION PLAN GENERAL NOTES

A. Coordinate demolition with new construction. All demolition and repair necessary to accomplish new construction shall be included. Contractor shall remove all existing improvements whether or not specifically indicated on the drawings to facilitate the completion of all required work. Contractors shall visit the site and verify all quantities and items required to be removed.

> B. Where gypsum board is to remain, patch, tape and float portion of wall to match adjacent new finish.

C. Contractor to coordinate demolition so all wiring, conduit, equipment, etc. to remain is not damaged. Certain items may be temporarily removed and replaced later during course of restoration. General Contractor will be required to incorporate this work into their schedule. The systems may include, but are not limited to the following: EMS/controls, electrical power and lighting, data, audiovisual, security, intercom, CATV, etc. Contractor to tag and loop wire to remain back to control panels, typical.

D. Contractor shall remove and replace any fireproofing or firestopping damage during demolition or new construction to conform to proper rating.

E. Contractor shall coordinate any shutdown required during demolition with Owner.

F. Contractor to maintain or repair fire and smoke ratings of existing floor, roof and wall assemblies throughout.

RECPTION

GENERAL FLOOR PLAN NOTES

A. Dimensions are to face of masonry, concrete and gypsum board and centerline of columns unless noted otherwise.

structural items, etc.

B. Field verify all dimensions prior to fabrication of any cabinetry, frames,

C. Provide painted access panels in walls and ceilings at concealed items, such as valves, shock absorbers, controls, switches, etc., and any other items that may require access. It is the Contractor's responsibility to determine access panel locations.

D. Verify and coordinate all requirements for owner furnished items, prior to performance of any work that is to accommodate and interface with such

E. All angles are increments of 45 degrees unless noted otherwise.

F. All frame walls to be Type S01, unless noted otherwise.

H. Repair all finish surface around door and effected area. Match paint to

adjacent wall. Secure any loose flooring effected by door installation. I. Mount all card readers 40" A.F.F. to the center of device, U.N.O. Provide card readers with conduits in wall cavity, no surface mounted

conduits, U.N.O., or approved by architect.

REMOVE HOLLOW METAL FRAME AND WOOD DOOR

J. Reference Electrcial plans for power to Card Readers and Electric Strikes.

K. All door frames in scope, noted with door tag and ref. door schdule, to have new painted finish to match existing door frames per school. All door finish to match existing doors per school.

L. Doors shown at 45 degrees are exist doors. See plans for notes were existing doors will require repair/upgrade.

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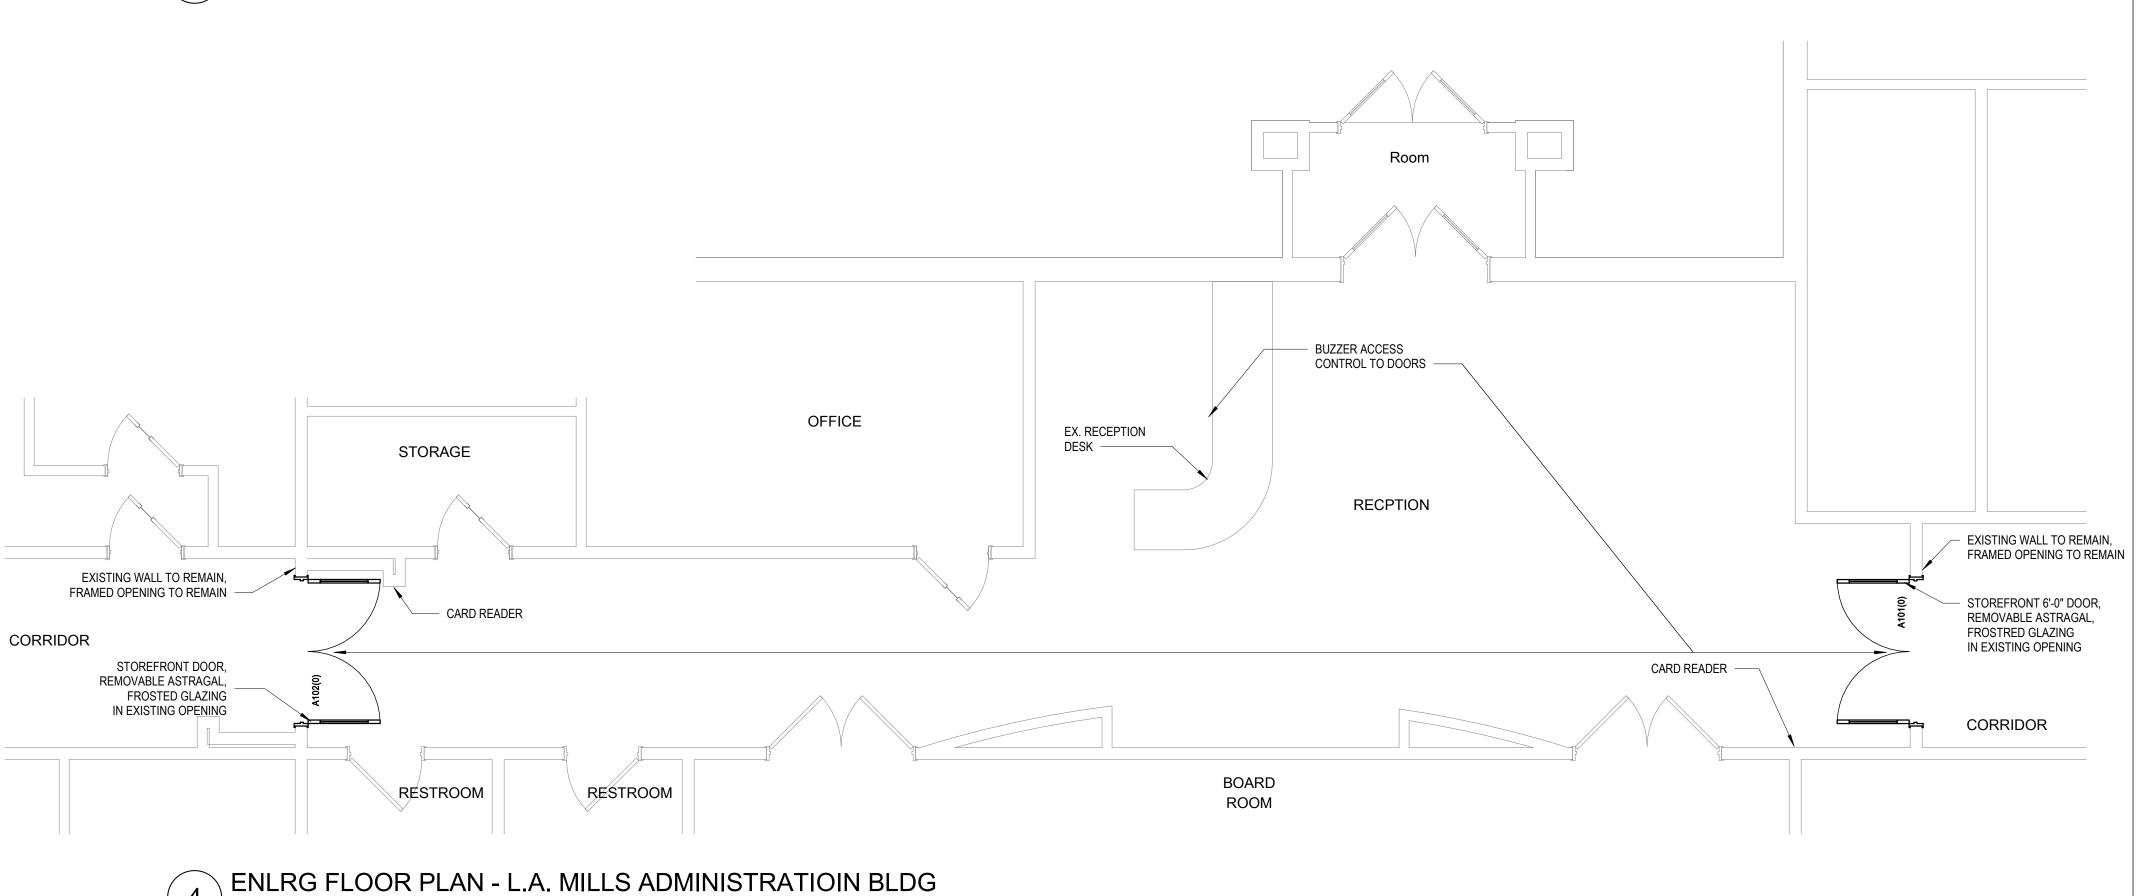
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AREA OF WORK OFFICE EX. RECEPTION STORAGE 9.A.3.J REMOVE HOLLOW METAL FRAME AND WOOD DOOR CORRIDOR BOARD ROOM RESTROOM

2 EXISTING BUILDING PLAN
1" = 30'-0"

1 SITE AERIAL
1" = 50'-0"



CORRIDOR

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PROJECT TEAM DRAWN BY TX Ed Studio PROJECT PHASE

Construction Documents

SHEET CONTENTS FIRST FLOOR PLAN -L.A. MILLS ADMIN

SHEET NO.

T.E. BAXTER ELEMENTARY SCHOOL 1050 PARK PLACE BLVD. MIDLOTHIAN, TX 76065

DEMOLITION LEGEND EXISTING WALLS, STRUCTURE, WINDOWS, ETC. TO REMAIN EXISTING WALL TO BE REMOVED EXISTING DOOR & FRAME TO BE

LINE OF EXISTING WALK, STAIR, FIXTURE OR OTHER SIMILAR ITEM TO BE REMOVED. EXISTING WINDOW TO BE REMOVED

SHADING INDICATES AREAS WHERE FINISHES ARE TO BE REMOVED. SEE KEYNOTES FOR FURTHER ADDITIONAL INFORMATION. FINISHES INCLUDE ALL FLOOR COVERING, BASE, WALL COVERING, CEILINGS, ETC. COORD. W/ MECHANICAL, ELECTRICAL & PLUMBING


DEMOLITION PLAN GENERAL NOTES

- A. Coordinate demolition with new construction. All demolition and repair necessary to accomplish new construction shall be included. Contractor shall remove all existing improvements whether or not specifically indicated on the drawings to facilitate the completion of all required work. Contractors shall visit the site and verify all quantities and items required to be removed.
 - B. Where gypsum board is to remain, patch, tape and float portion of wall to match adjacent new finish.
 - C. Contractor to coordinate demolition so all wiring, conduit, equipment, etc. to remain is not damaged. Certain items may be temporarily removed and replaced later during course of restoration. General Contractor will be required to incorporate this work into their schedule. The systems may include, but are not limited to the following: EMS/controls, electrical power and lighting, data, audiovisual, security, intercom, CATV, etc. Contractor to tag and loop wire to remain back to control panels, typical.
 - D. Contractor shall remove and replace any fireproofing or firestopping damage during demolition or new construction to conform to proper rating.
 - E. Contractor shall coordinate any shutdown required during demolition with Owner.
 - F. Contractor to maintain or repair fire and smoke ratings of existing floor, roof and wall assemblies throughout.

- GENERAL FLOOR PLAN NOTES
 - A. Dimensions are to face of masonry, concrete and gypsum board and centerline of columns unless noted otherwise.

structural items, etc.

- B. Field verify all dimensions prior to fabrication of any cabinetry, frames,
- C. Provide painted access panels in walls and ceilings at concealed items, such as valves, shock absorbers, controls, switches, etc., and any other items that may require access. It is the Contractor's responsibility to determine access panel locations.
- D. Verify and coordinate all requirements for owner furnished items, prior to performance of any work that is to accommodate and interface with such
- E. All angles are increments of 45 degrees unless noted otherwise.
- F. All frame walls to be Type S01, unless noted otherwise.
- H. Repair all finish surface around door and effected area. Match paint to adjacent wall. Secure any loose flooring effected by door installation.
- I. Mount all card readers 40" A.F.F. to the center of device, U.N.O. Provide card readers with conduits in wall cavity, no surface mounted conduits, U.N.O., or approved by architect.
- J. Reference Electrcial plans for power to Card Readers and Electric Strikes.
- K. All door frames in scope, noted with door tag and ref. door schdule, to have new painted finish to match existing door frames per school. All door finish to match existing doors per school.
- L. Doors shown at 45 degrees are exist doors. See plans for notes were existing doors will require repair/upgrade.

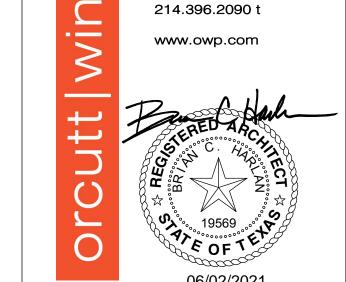

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OWP PROJECT NO. DATE OF ISSUE 06.02.2021 2021_097

REVISIONS

PROJECT TEAM DRAWN BY TX Ed Studio


PROJECT PHASE Construction Documents

SHEET CONTENTS FIRST FLOOR PLAN -

SHEET NO.


BAXTER E.S.


A-102

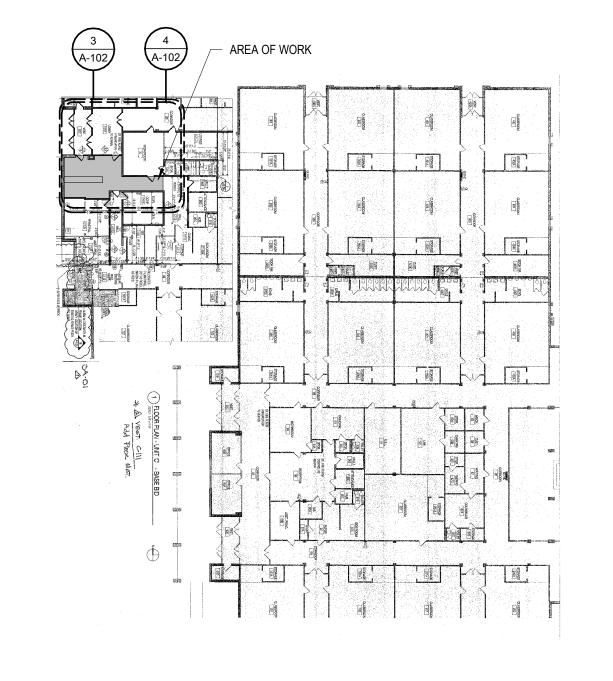

EXISTING BUILDING PLAN




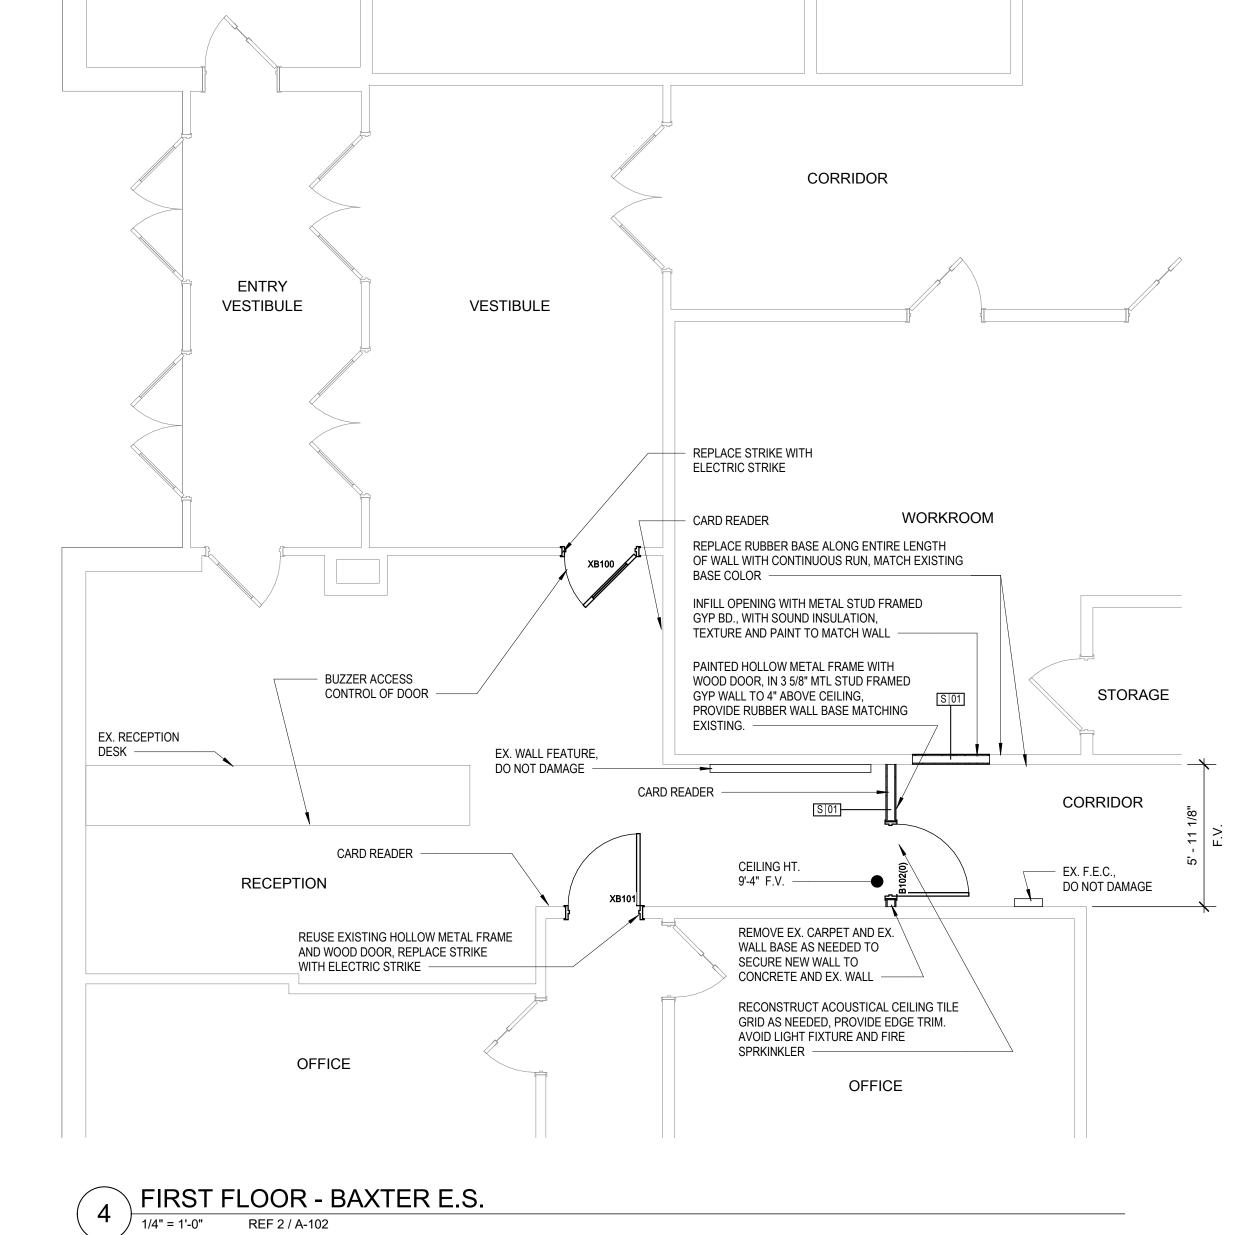

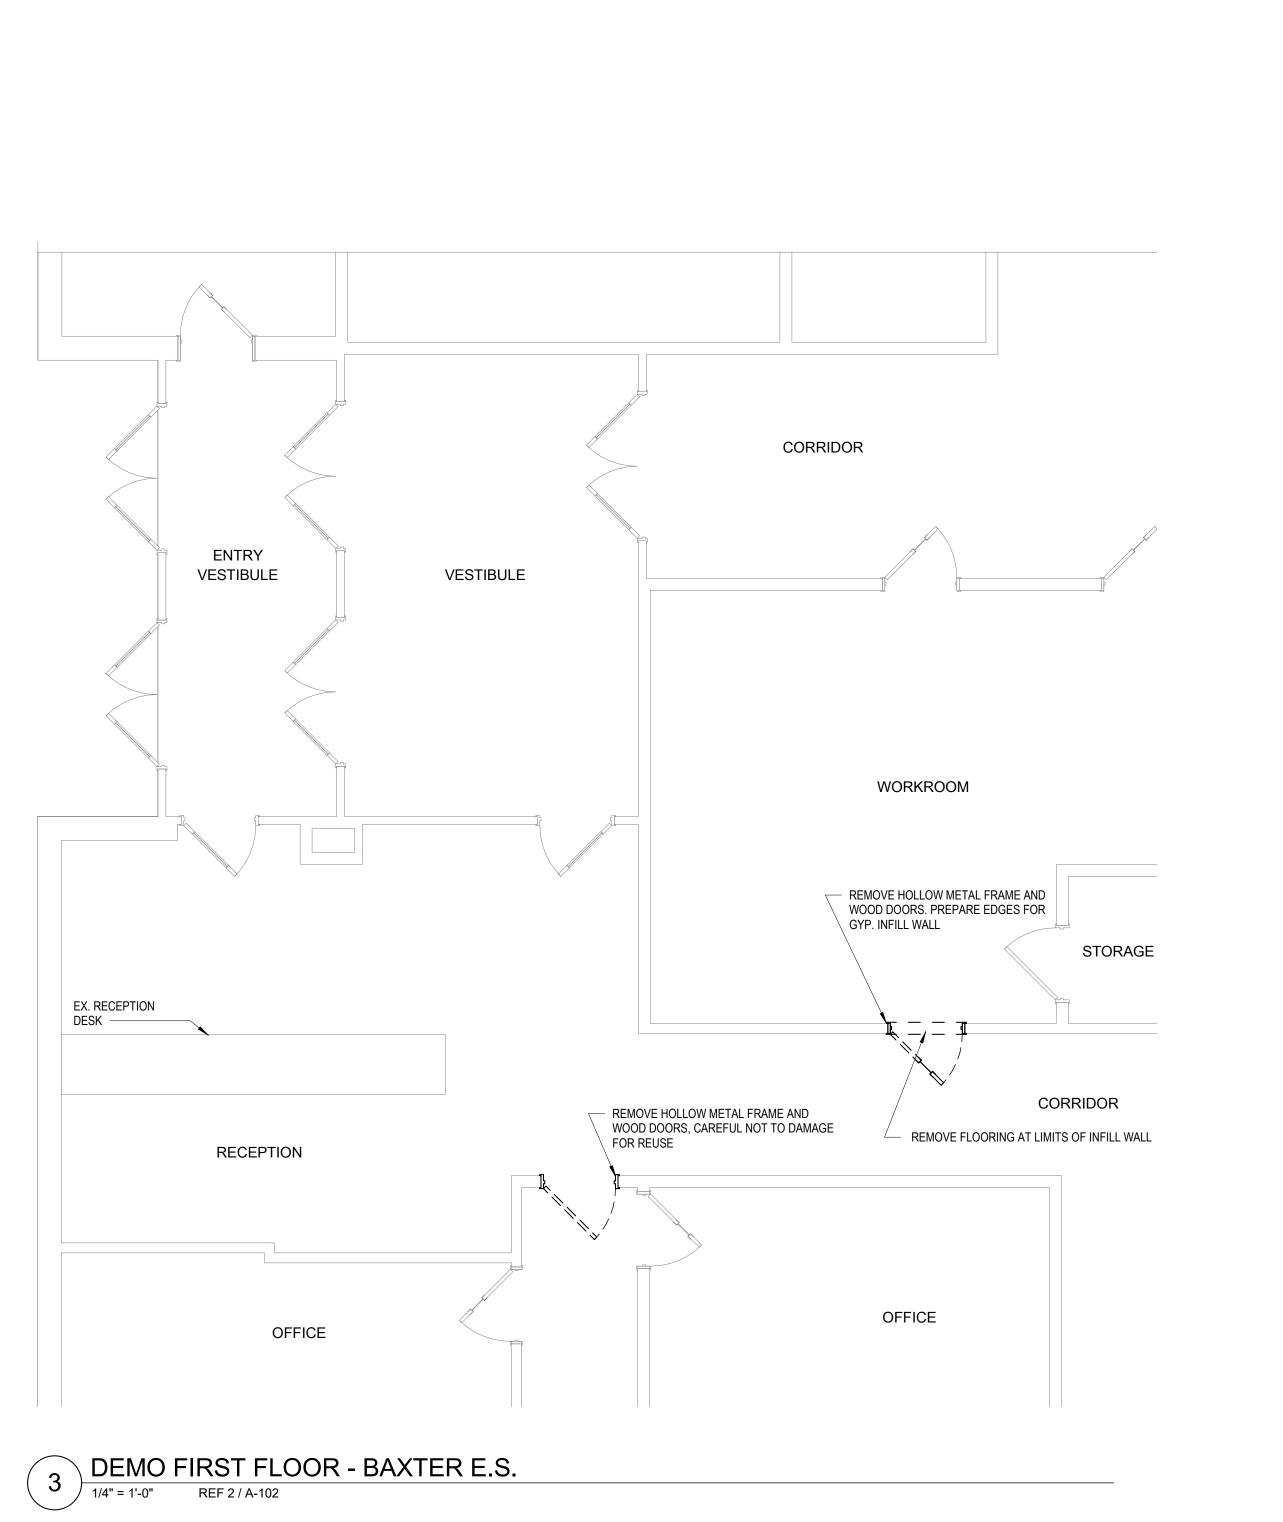

LONGBRANCH ELEMENTARY SCHOOL 6631 FM 1387 MIDLOTHIAN, TX 76065

1 SITE AERIAL
1" = 80'-0"

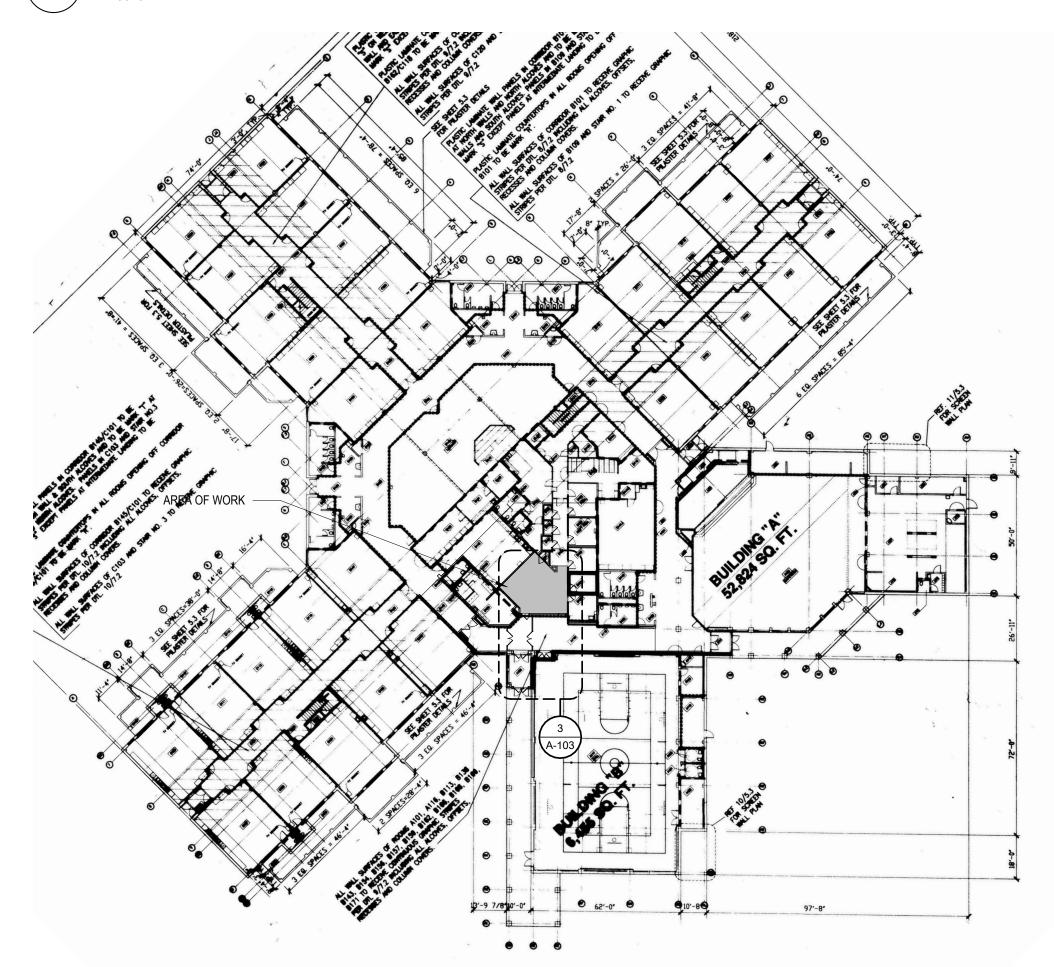

2 EXISTING BUILDING PLAN
1" = 40'-0"

- A. Coordinate demolition with new construction. All demolition and repair necessary to accomplish new construction shall be included. Contractor shall remove all existing improvements whether or not specifically indicated on the drawings to facilitate the completion of all required work. Contractors shall visit the site and verify all quantities and items required to be removed.
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- E. Contractor shall coordinate any shutdown required during demolition with Owner.
- F. Contractor to maintain or repair fire and smoke ratings of existing floor, roof and wall assemblies throughout.

DEMOLITION PLAN GENERAL NOTES


- - adjacent new finish.

C. Contractor to coordinate demolition so all wiring, conduit, equipment, etc. to remain is

- demolition or new construction to conform to proper rating.

- B. Where gypsum board is to remain, patch, tape and float portion of wall to match
- course of restoration. General Contractor will be required to incorporate this work into EMS/controls, electrical power and lighting, data, audiovisual, security, intercom, CATV, etc. Contractor to tag and loop wire to remain back to control panels, typical.
- D. Contractor shall remove and replace any fireproofing or firestopping damage during

- GENERAL FLOOR PLAN NOTES
- A. Dimensions are to face of masonry, concrete and gypsum board and centerline of columns unless noted otherwise.
- B. Field verify all dimensions prior to fabrication of any cabinetry, frames, structural items, etc.
- C. Provide painted access panels in walls and ceilings at concealed items, such as valves, shock absorbers, controls, switches, etc., and any other items that may require access. It is the Contractor's responsibility to determine access panel locations.
- D. Verify and coordinate all requirements for owner furnished items, prior to performance of any work that is to accommodate and interface with such
- E. All angles are increments of 45 degrees unless noted otherwise.
- F. All frame walls to be Type S01, unless noted otherwise.
- H. Repair all finish surface around door and effected area. Match paint to
- adjacent wall. Secure any loose flooring effected by door installation. I. Mount all card readers 40" A.F.F. to the center of device, U.N.O.
- Provide card readers with conduits in wall cavity, no surface mounted conduits, U.N.O., or approved by architect.
- J. Reference Electrcial plans for power to Card Readers and Electric Strikes.
- K. All door frames in scope, noted with door tag and ref. door schdule, to have new painted finish to match existing door frames per school. All door finish to match existing doors per school.
- L. Doors shown at 45 degrees are exist doors. See plans for notes were existing doors will require repair/upgrade.

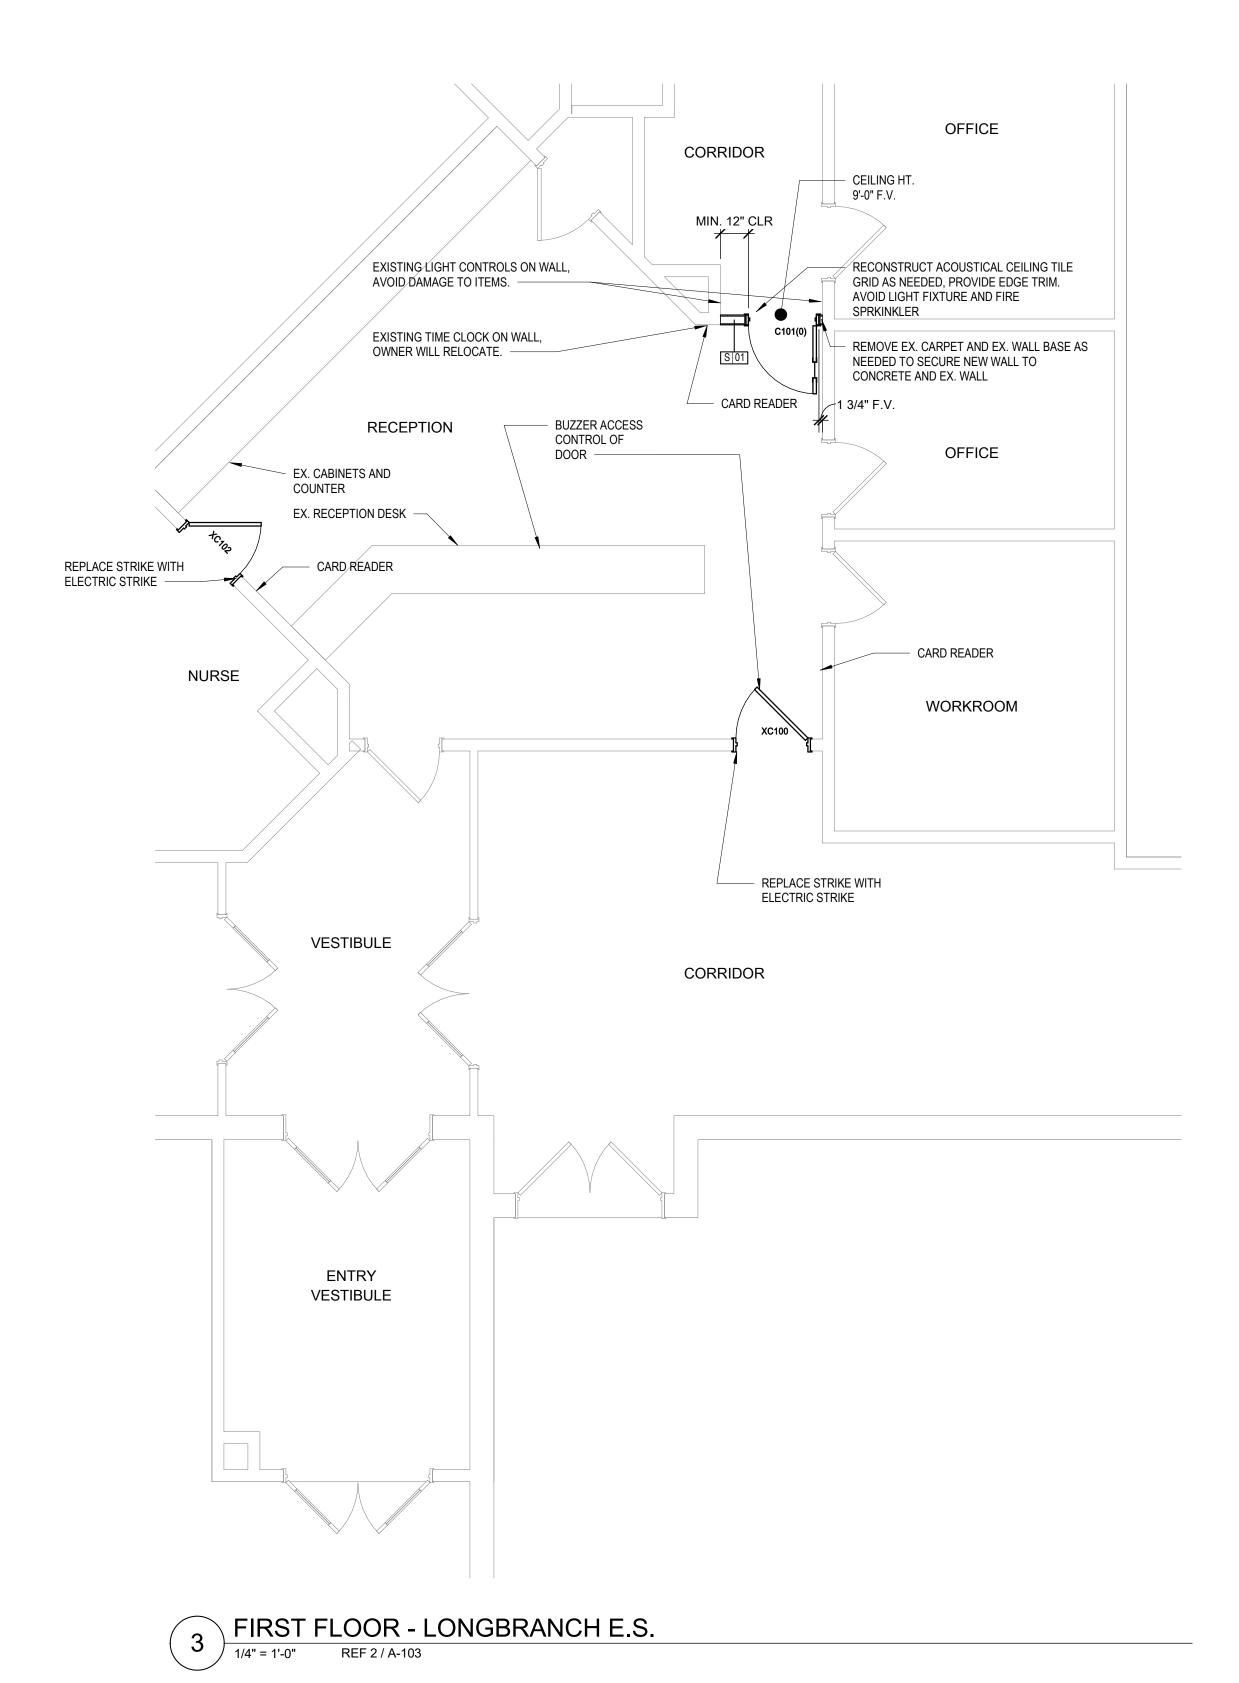

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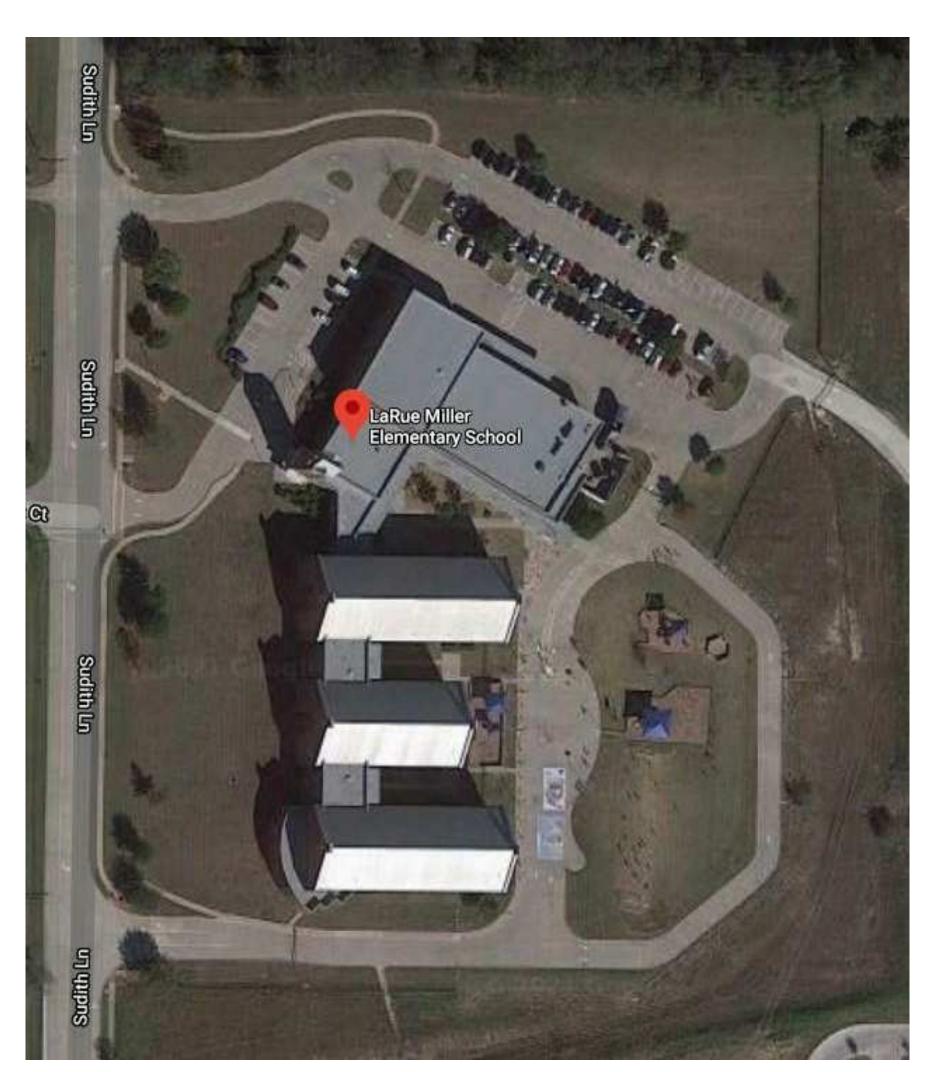
OWP PROJECT NO. DATE OF ISSUE

PROJECT TEAM DRAWN BY


TX Ed Studio PROJECT PHASE

Construction Documents SHEET CONTENTS FIRST FLOOR PLAN -

LONGBRANCH E.S. SHEET NO.



SITE AERIAL

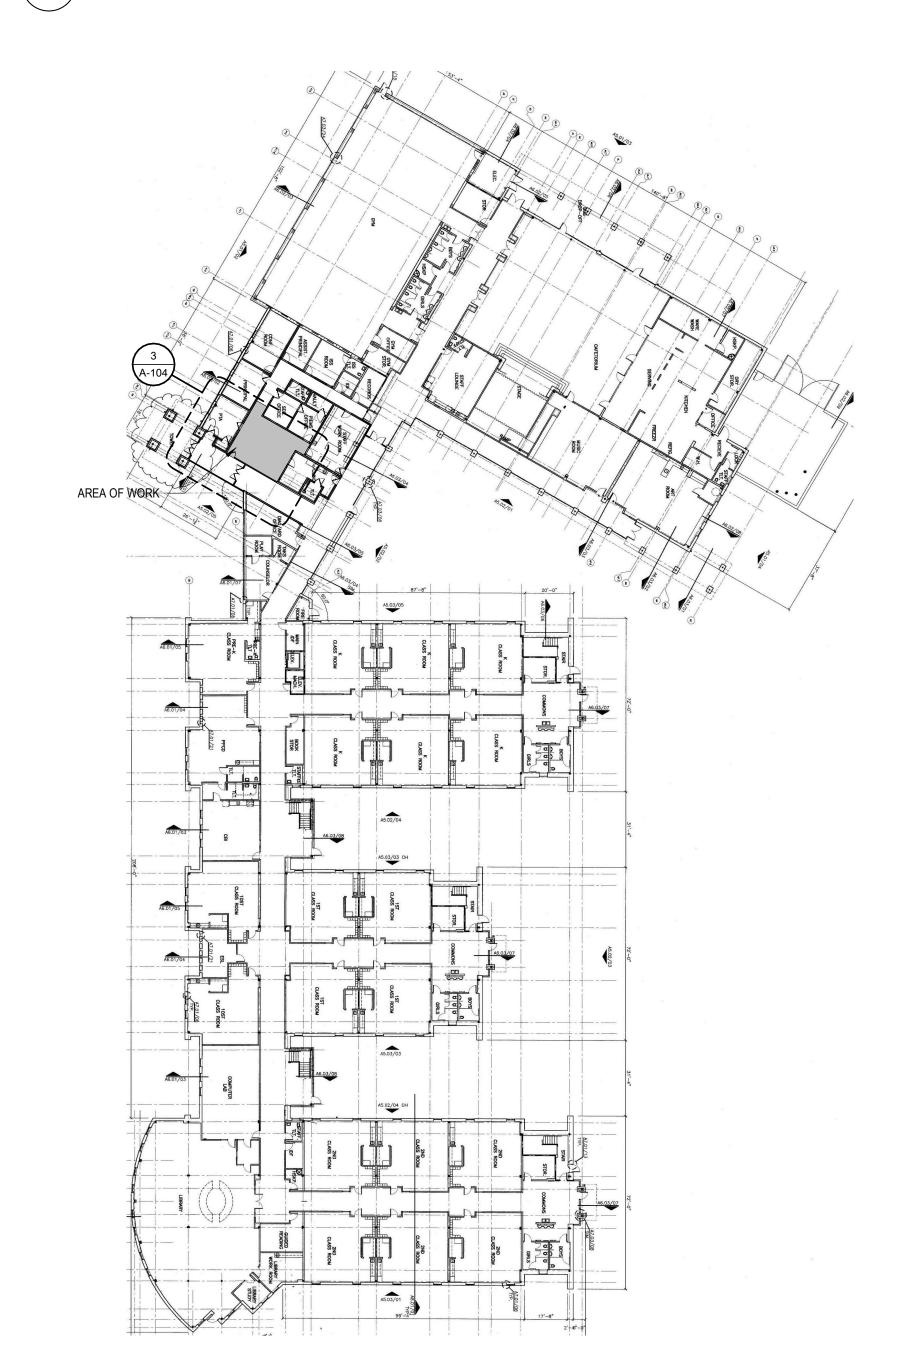

2 EXISTING BUILDING PLAN

1" = 40'-0"

- accomplish new construction shall be included. Contractor shall remove all existing improvements whether or not specifically indicated on the drawings to facilitate the completion of all required work. Contractors shall visit the site and verify all quantities and items required to be removed.
- B. Where gypsum board is to remain, patch, tape and float portion of wall to match adjacent new finish.
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CATV, etc. Contractor to tag and loop wire to remain back to control panels, typical.

- D. Contractor shall remove and replace any fireproofing or firestopping damage during demolition or new construction to conform to proper rating.
- E. Contractor shall coordinate any shutdown required during demolition with Owner.


DEMOLITION PLAN GENERAL NOTES

- A. Coordinate demolition with new construction. All demolition and repair necessary to
- F. Contractor to maintain or repair fire and smoke ratings of existing floor, roof and wall assemblies throughout.

GENERAL FLOOR PLAN NOTES

- A. Dimensions are to face of masonry, concrete and gypsum board and centerline of columns unless noted otherwise.
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- items that may require access. It is the Contractor's responsibility to determine access panel locations.
- E. All angles are increments of 45 degrees unless noted otherwise.
- F. All frame walls to be Type S01, unless noted otherwise.

- Provide card readers with conduits in wall cavity, no surface mounted conduits, U.N.O., or approved by architect.
- new painted finish to match existing door frames per school. All door finish to match existing doors per school.

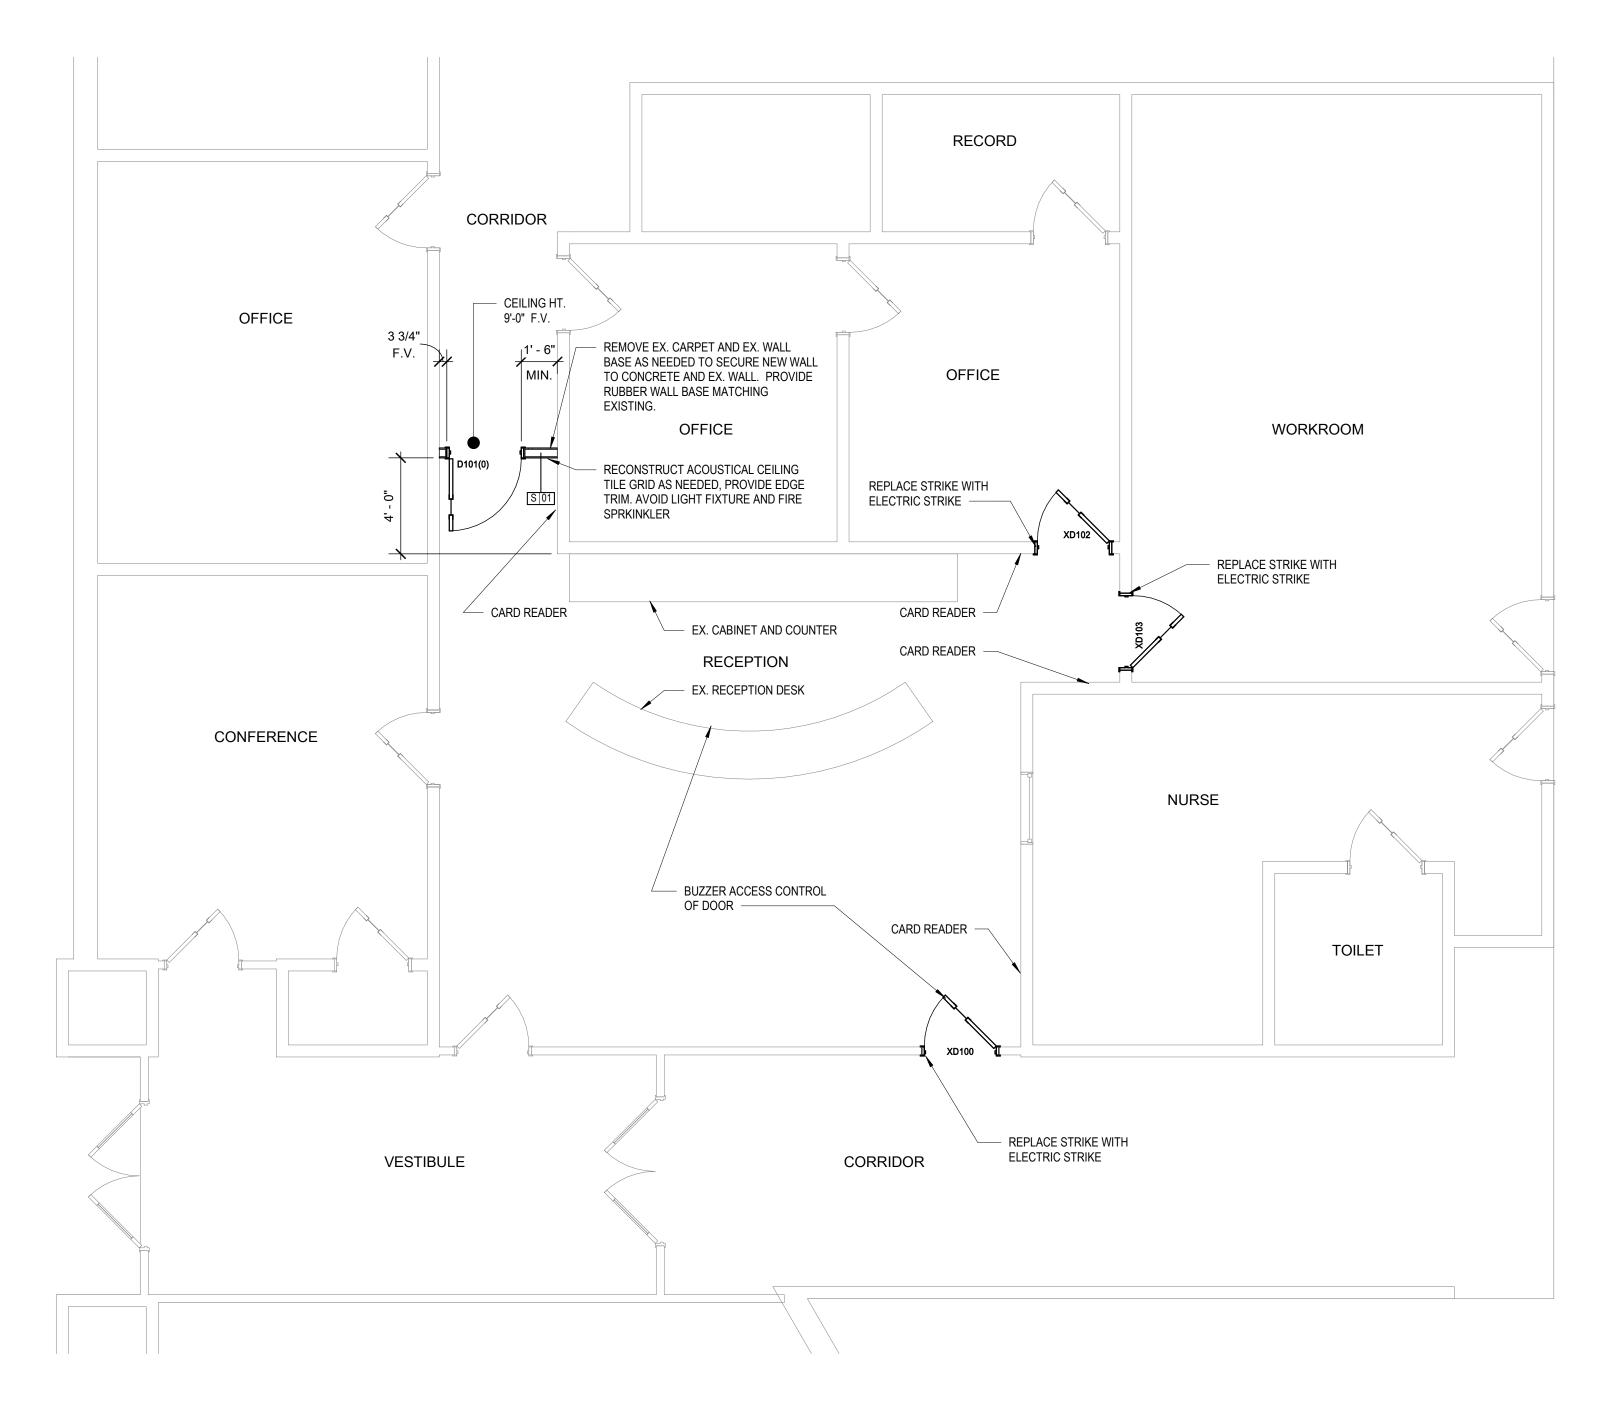

FIRST FLOOR - MILLER E.S.

1/4" = 1'-0" REF 2 / A-104

structural items, etc.

D. Verify and coordinate all requirements for owner furnished items, prior to

performance of any work that is to accommodate and interface with such

H. Repair all finish surface around door and effected area. Match paint to adjacent wall. Secure any loose flooring effected by door installation.

I. Mount all card readers 40" A.F.F. to the center of device, U.N.O.

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K. All door frames in scope, noted with door tag and ref. door schdule, to have

L. Doors shown at 45 degrees are exist doors. See plans for notes were existing doors will require repair/upgrade.

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2021_097 06.02.2021

PROJECT TEAM

TX Ed Studio

PROJECT PHASE Construction Documents


SHEET CONTENTS FIRST FLOOR PLAN -MILLER E.S.

A-104

SHEET NO.

MT. PEAK ELEMENTARY SCHOOL 5201 FM 663 MIDLOTHIAN, TX 76065



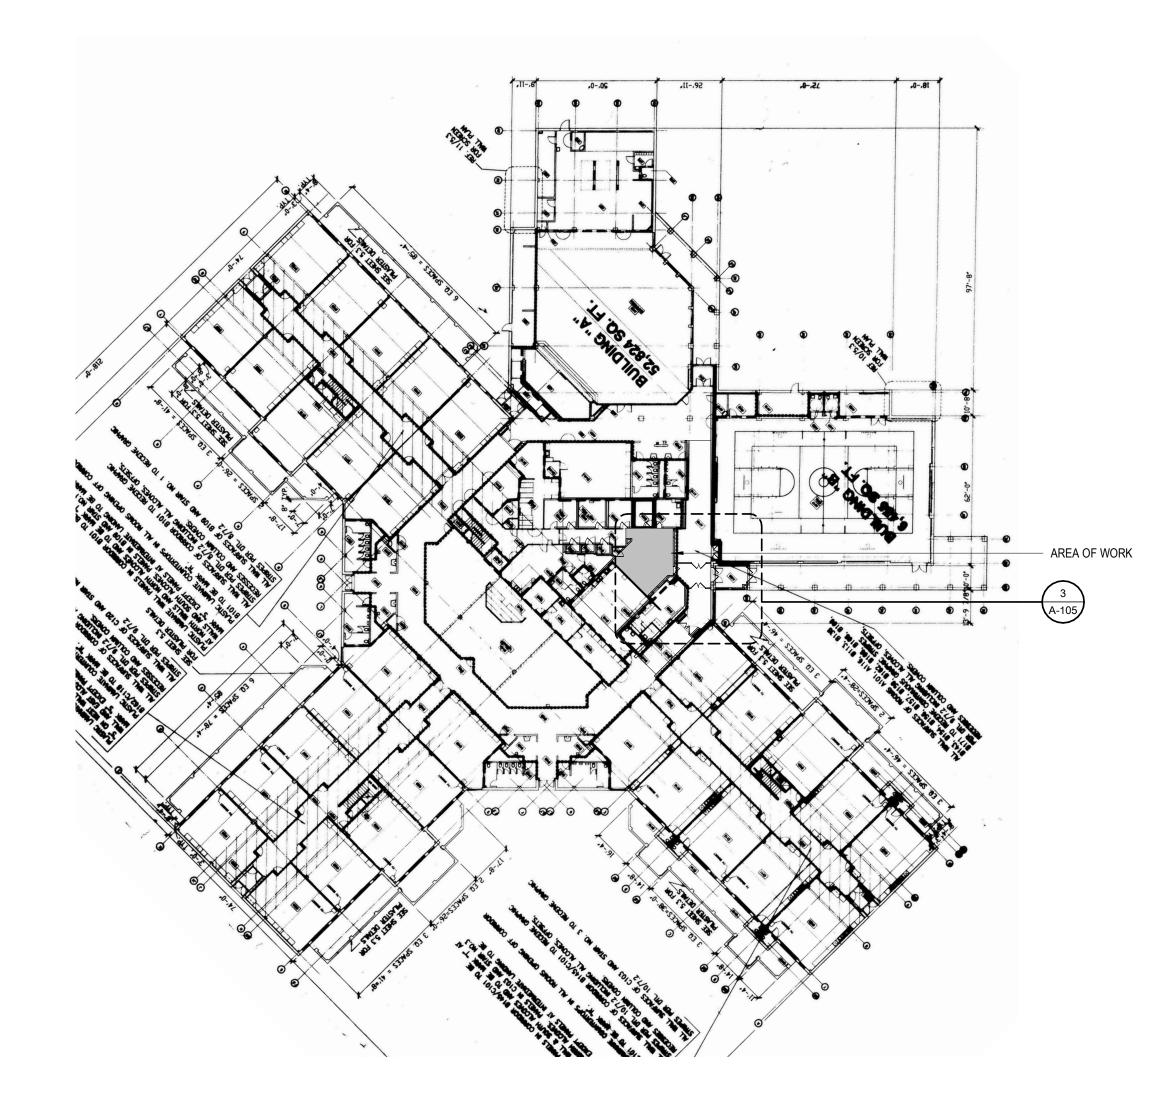

EXISTING BUILDING PLAN

DEMOLITION PLAN GENERAL NOTES

- accomplish new construction shall be included. Contractor shall remove all existing improvements whether or not specifically indicated on the drawings to facilitate the completion of all required work. Contractors shall visit the site and verify all quantities and items required to be removed.
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- D. Contractor shall remove and replace any fireproofing or firestopping damage during demolition or new construction to conform to proper rating.
- E. Contractor shall coordinate any shutdown required during demolition with Owner.
- - their schedule. The systems may include, but are not limited to the following: CATV, etc. Contractor to tag and loop wire to remain back to control panels, typical.

REMOVE EX. CARPET AND EX. WALL BASE AS NEEDED TO SECURE NEW WALL

RECONSTRUCT ACOUSTICAL CEILING TILE GRID AS NEEDED, PROVIDE EDGE TRIM. AVOID LIGHT FIXTURE AND FIRE

EXISTING LIGHT CONTROLS ON WALL,

AVOID DAMAGE TO ITEMS. -

OFFICE

OFFICE

WORKROOM

CARD READER -

- EXISTING TIME CLOCK ON WALL,

TO CONCRETE AND EX. WALL

- A. Coordinate demolition with new construction. All demolition and repair necessary to
- B. Where gypsum board is to remain, patch, tape and float portion of wall to match adjacent new finish.
- EMS/controls, electrical power and lighting, data, audiovisual, security, intercom,

- F. Contractor to maintain or repair fire and smoke ratings of existing floor, roof and wall assemblies throughout.

GENERAL FLOOR PLAN NOTES

A. Dimensions are to face of masonry, concrete and gypsum board and centerline of columns unless noted otherwise.

structural items, etc.

- B. Field verify all dimensions prior to fabrication of any cabinetry, frames,
- C. Provide painted access panels in walls and ceilings at concealed items, such as valves, shock absorbers, controls, switches, etc., and any other
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- L. Doors shown at 45 degrees are exist doors. See plans for notes were existing doors will require repair/upgrade.

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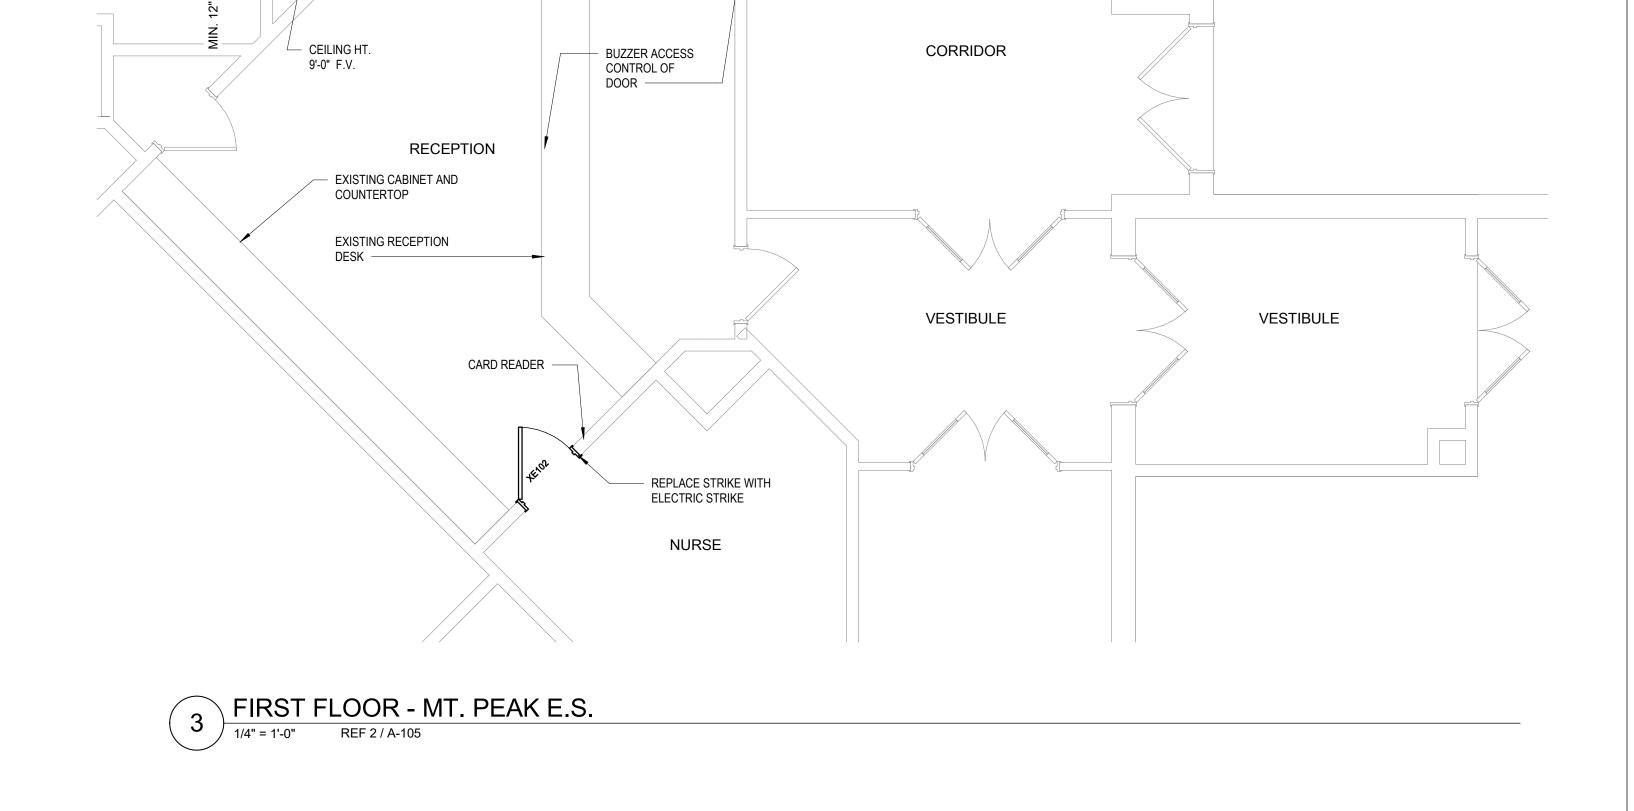
PROJECT TEAM

TX Ed Studio PROJECT PHASE


Construction Documents SHEET CONTENTS

FIRST FLOOR PLAN -MT. PEAK E.S.


SHEET NO. A-105



REPLACE STRIKE WITH ELECTRIC STRIKE

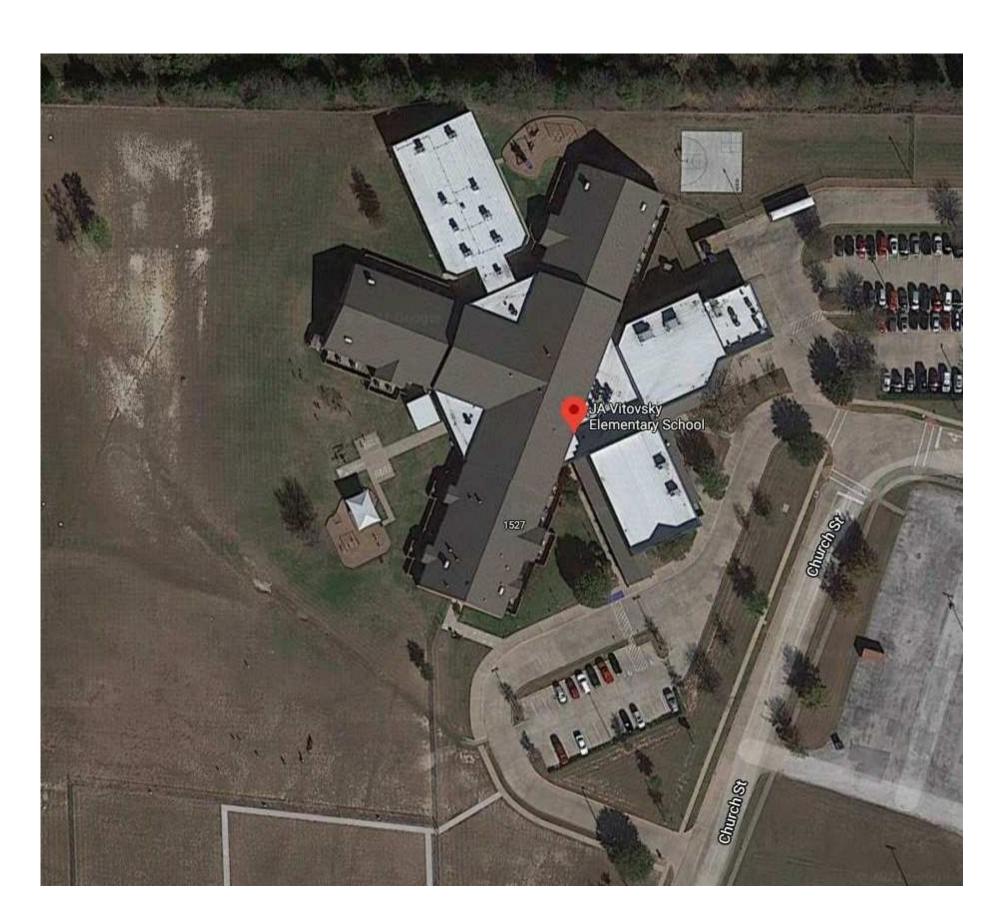

J.A. VITOVSKY ELEMENTARY SCHOOL 333 CHURCH ST. MIDLOTHIAN, TX 76065

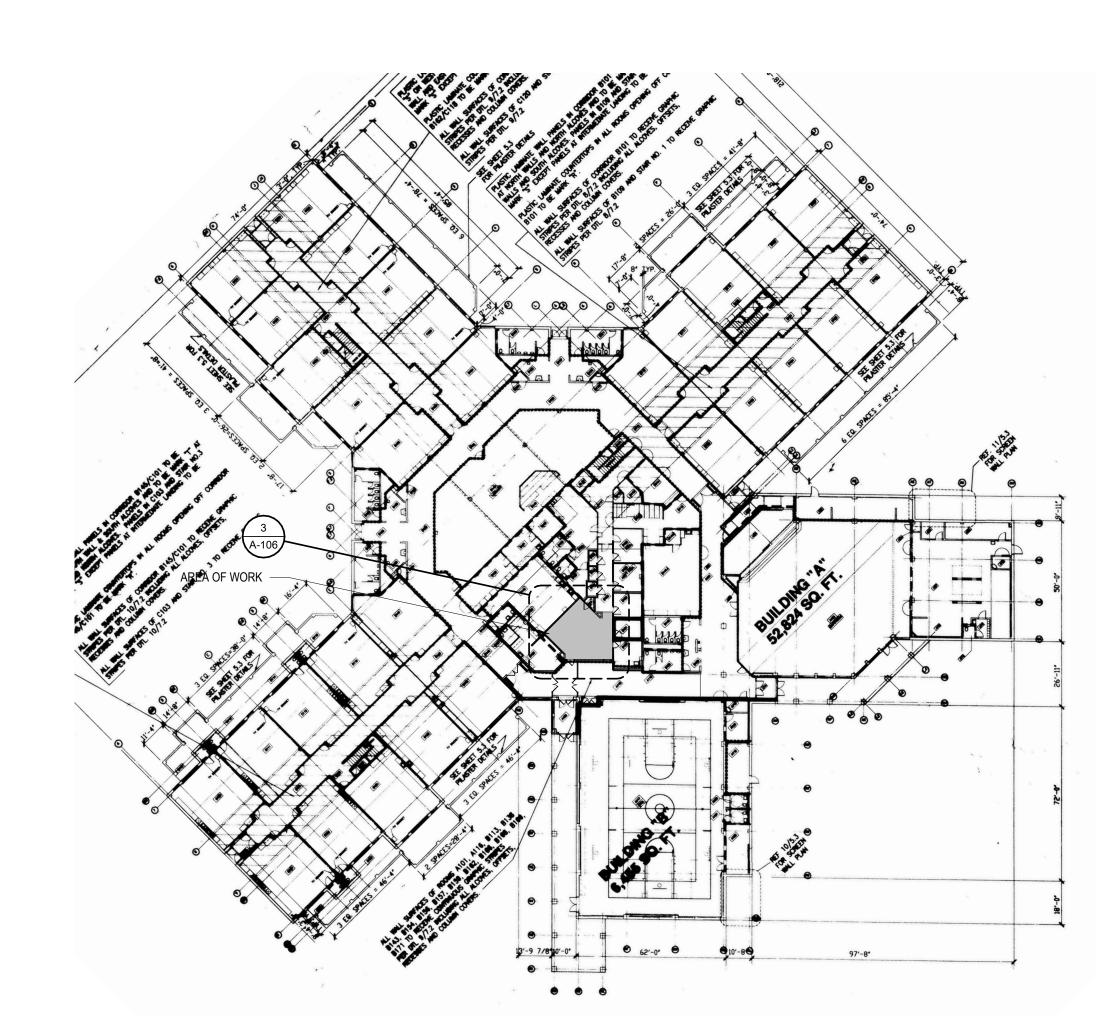

EXISTING BUILDING PLAN

DEMOLITION PLAN GENERAL NOTES


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GENERAL FLOOR PLAN NOTES

- centerline of columns unless noted otherwise.
- B. Field verify all dimensions prior to fabrication of any cabinetry, frames, structural items, etc.
- C. Provide painted access panels in walls and ceilings at concealed items, such as valves, shock absorbers, controls, switches, etc., and any other items that may require access. It is the Contractor's responsibility to determine access panel locations.
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- to match existing doors per school.
- existing doors will require repair/upgrade.



A. Dimensions are to face of masonry, concrete and gypsum board and

E. All angles are increments of 45 degrees unless noted otherwise.

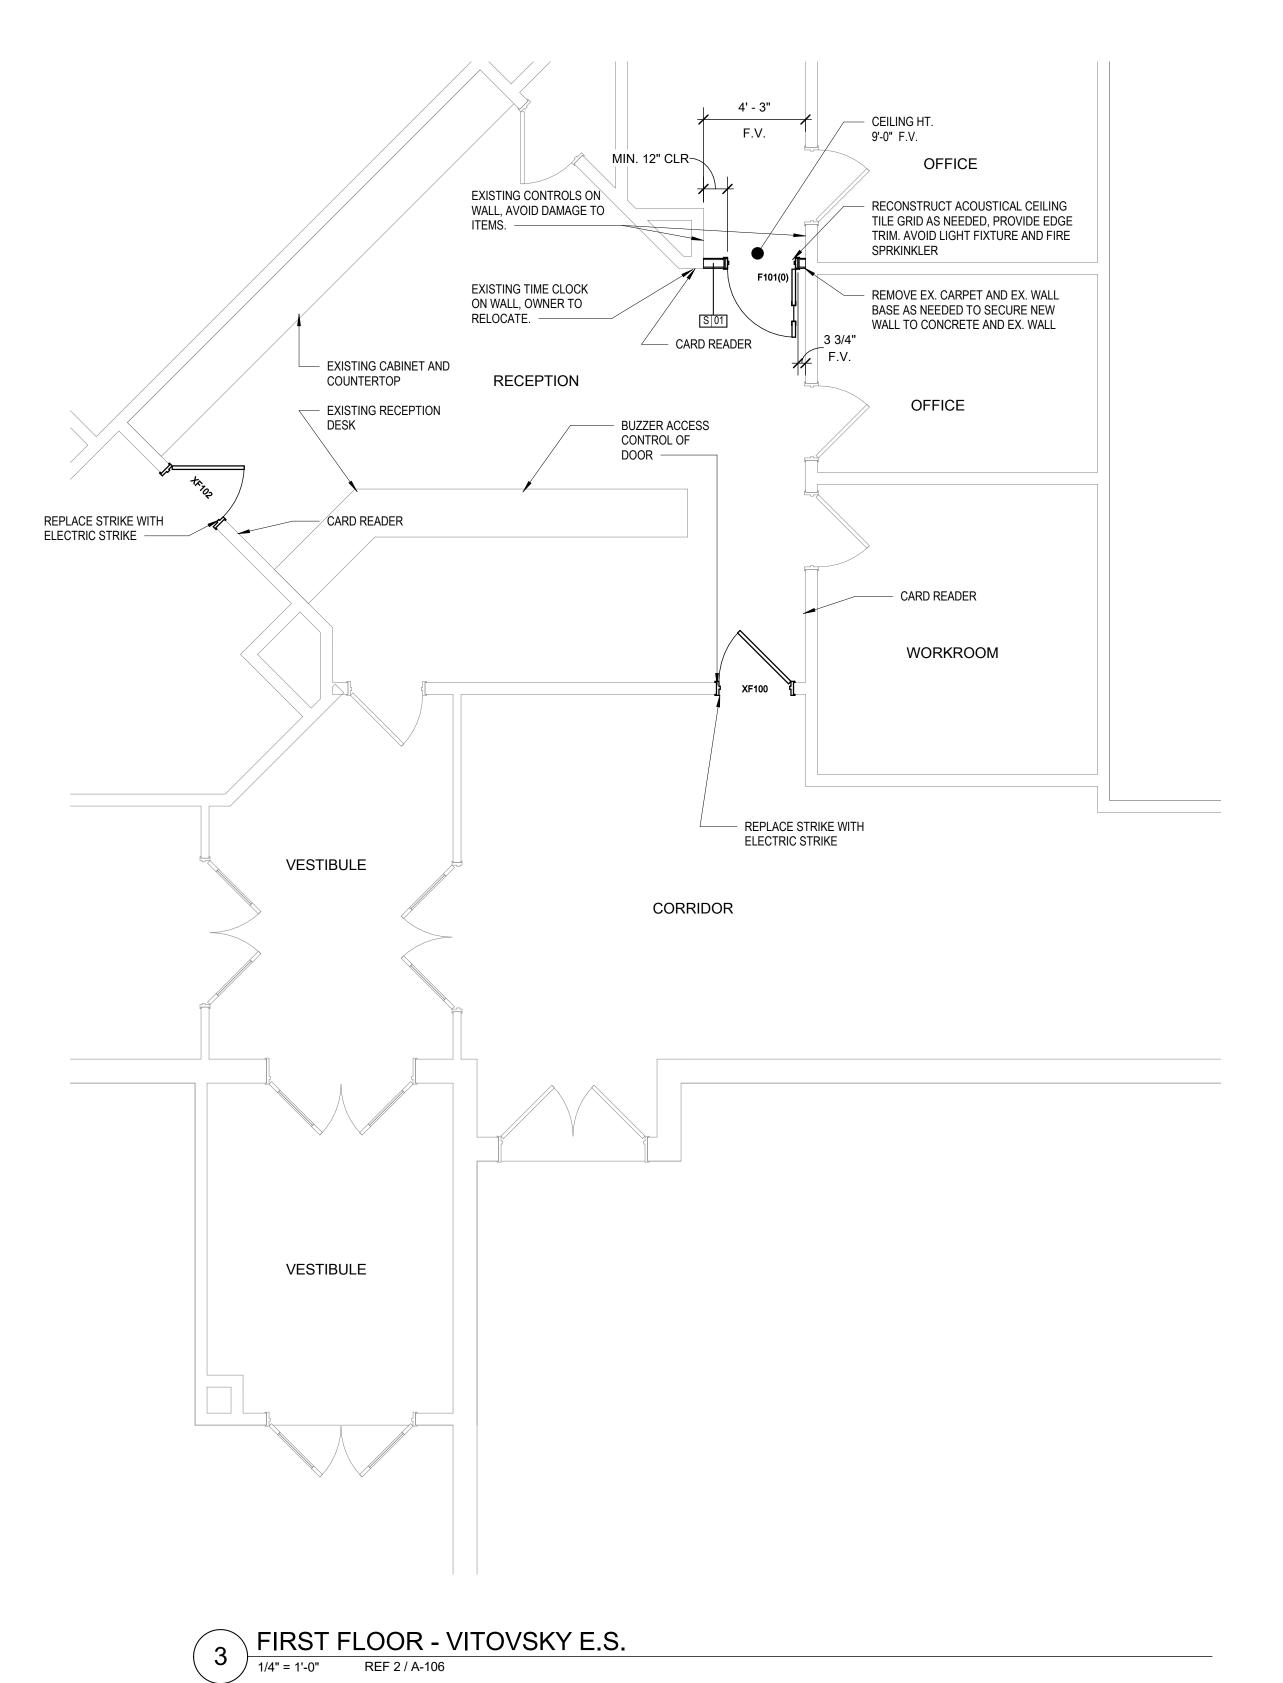F. All frame walls to be Type S01, unless noted otherwise.

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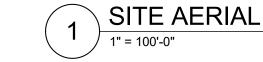
PROJECT TEAM


PROJECT PHASE Construction Documents

SHEET CONTENTS FIRST FLOOR PLAN -VITOVSKY E.S.

SHEET NO.

FRANK SEALE MIDDLE SCHOOL 700 GEORGE HOPPER RD. MIDLOTHIAN, TX 76065



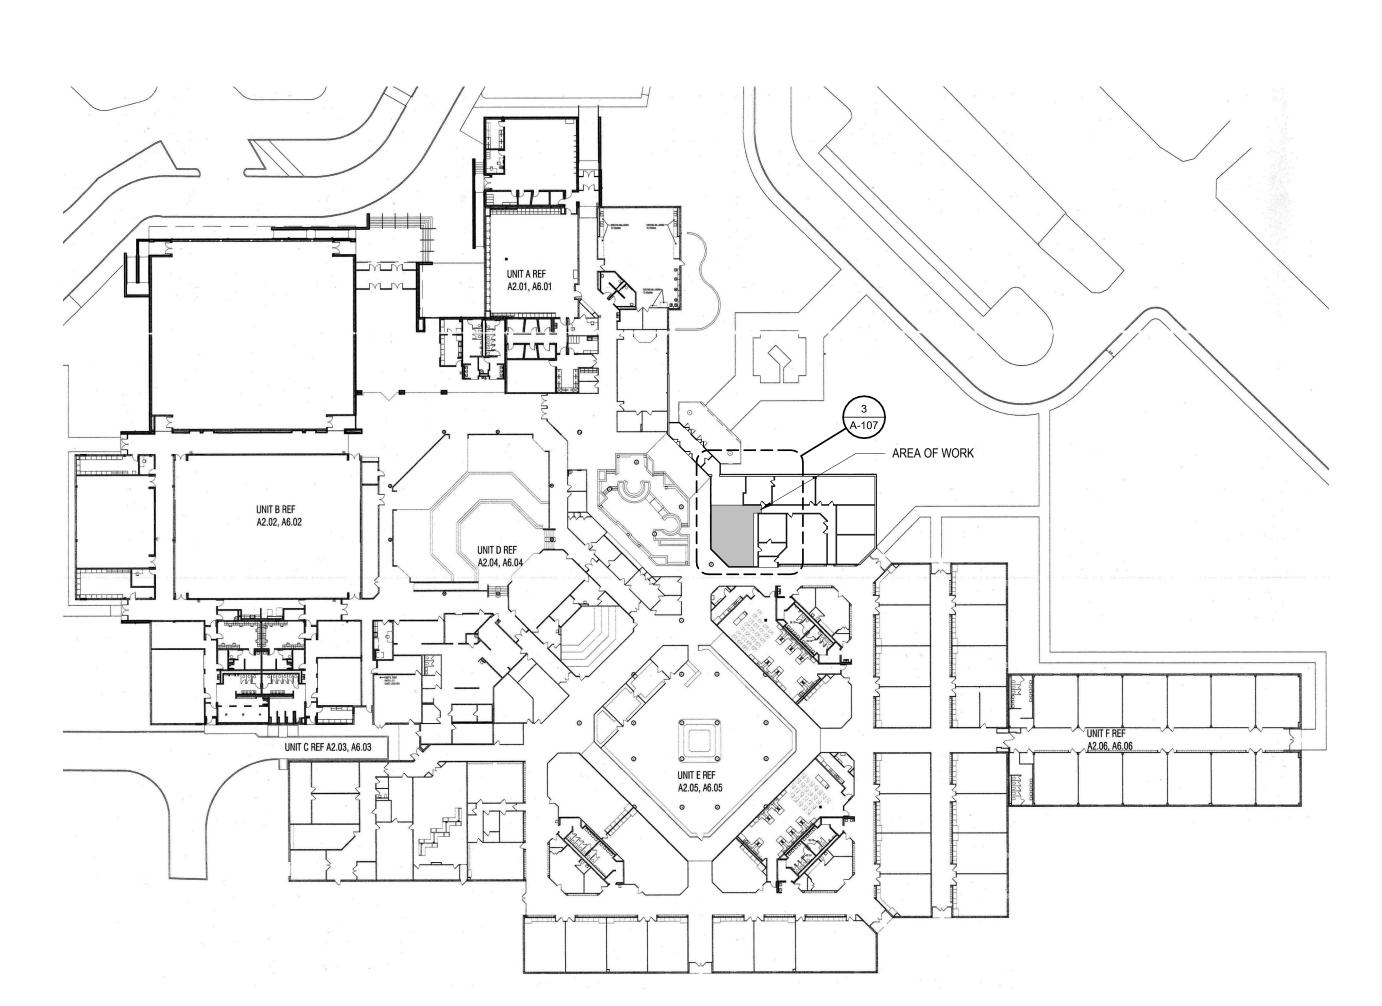

2 EXISTING BUILDING PLAN
1" = 60'-0"

DEMOLITION PLAN GENERAL NOTES


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- E. Contractor shall coordinate any shutdown required during demolition with Owner.
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- A. Coordinate demolition with new construction. All demolition and repair necessary to

GENERAL FLOOR PLAN NOTES

A. Dimensions are to face of masonry, concrete and gypsum board and centerline of columns unless noted otherwise.

structural items, etc.

- B. Field verify all dimensions prior to fabrication of any cabinetry, frames,
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REVISIONS

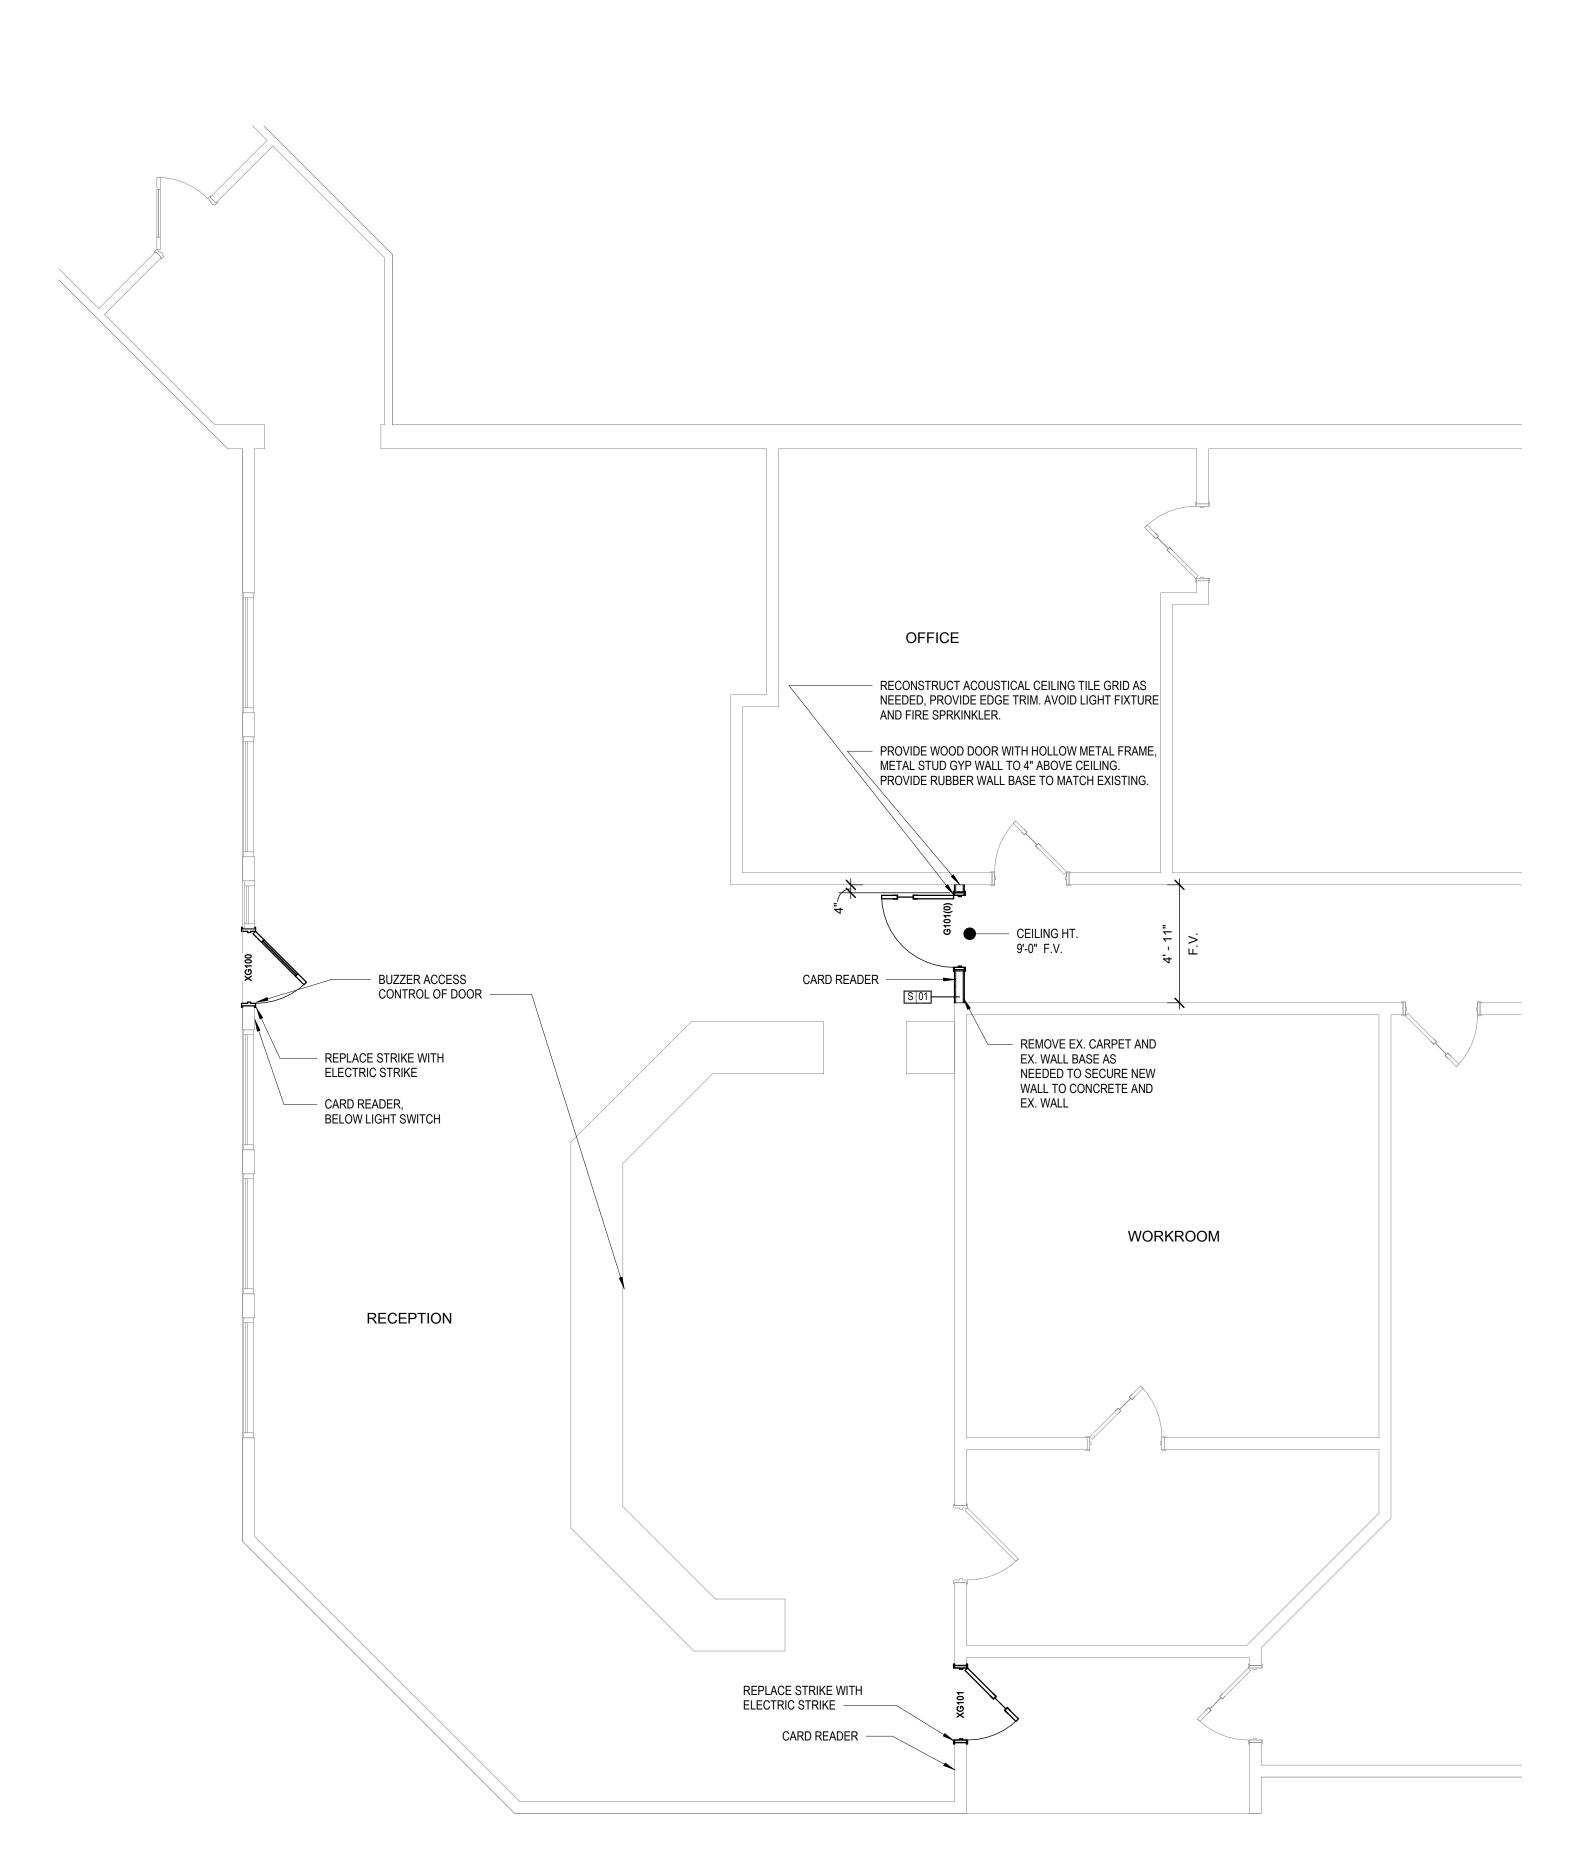
PROJECT TEAM TX Ed Studio

PROJECT PHASE **Construction Documents**

SHEET CONTENTS FIRST FLOOR PLAN -FRANK SEALE M.S.

WALNUT GROVE MIDDLE SCHOOL 990 N WALNUT GROVE RD. MIDLOTHIAN, TX 76065



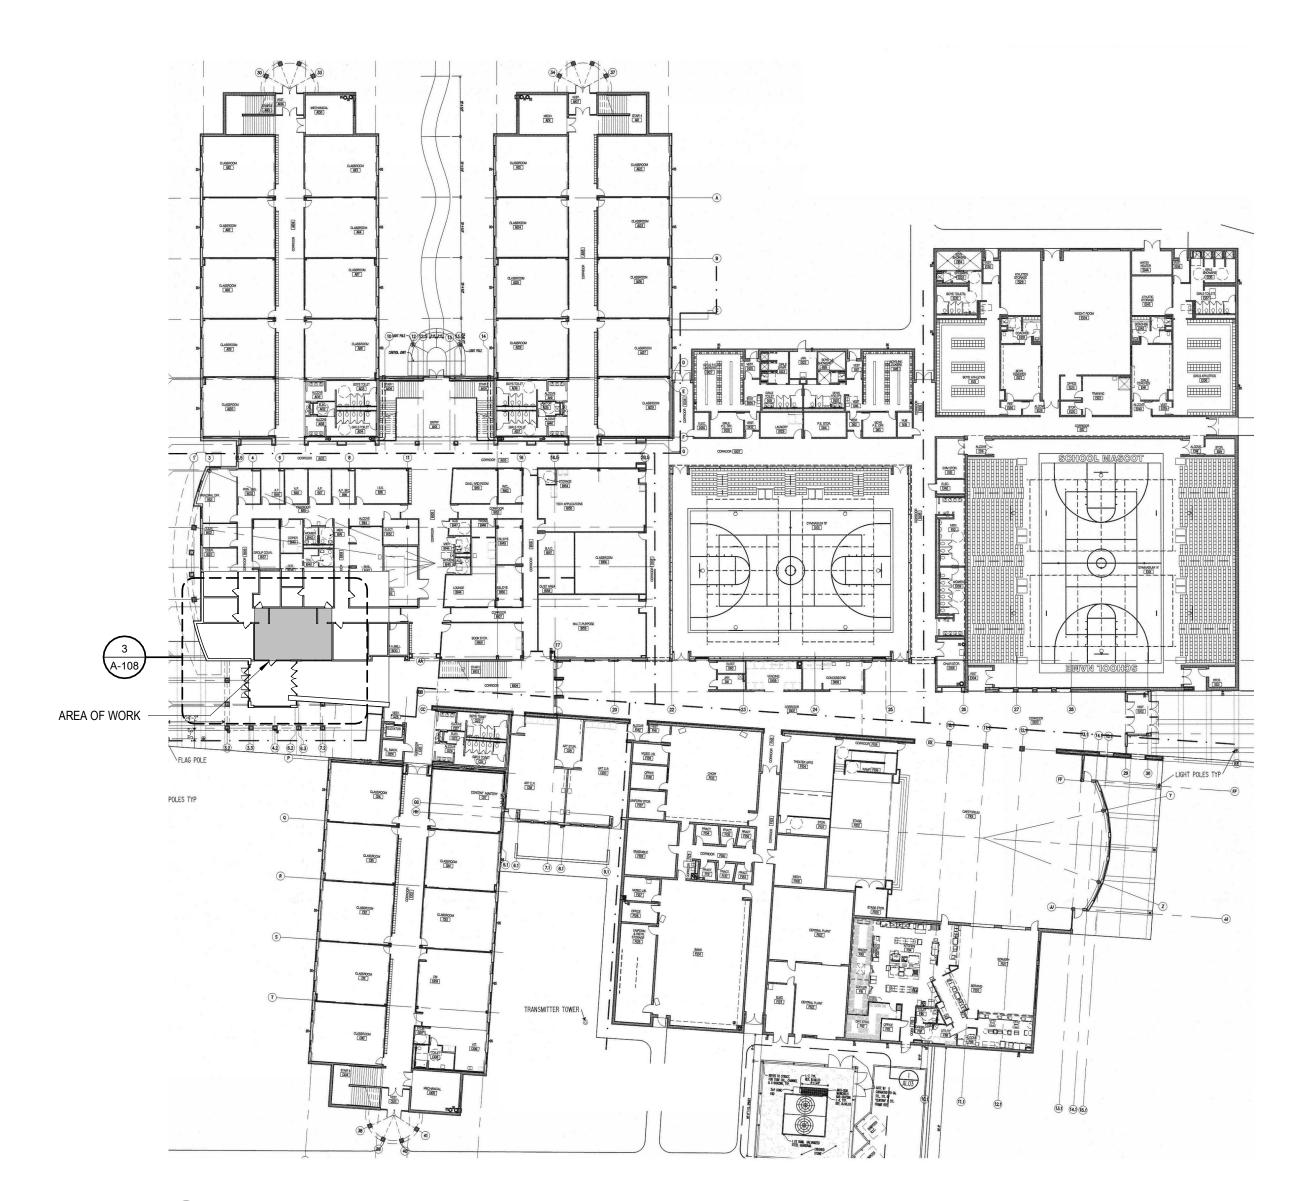

2 EXISTING BUILDING PLAN
1" = 40'-0"

DEMOLITION PLAN GENERAL NOTES

- A. Coordinate demolition with new construction. All demolition and repair necessary to accomplish new construction shall be included. Contractor shall remove all existing improvements whether or not specifically indicated on the drawings to facilitate the completion of all required work. Contractors shall visit the site and verify all quantities
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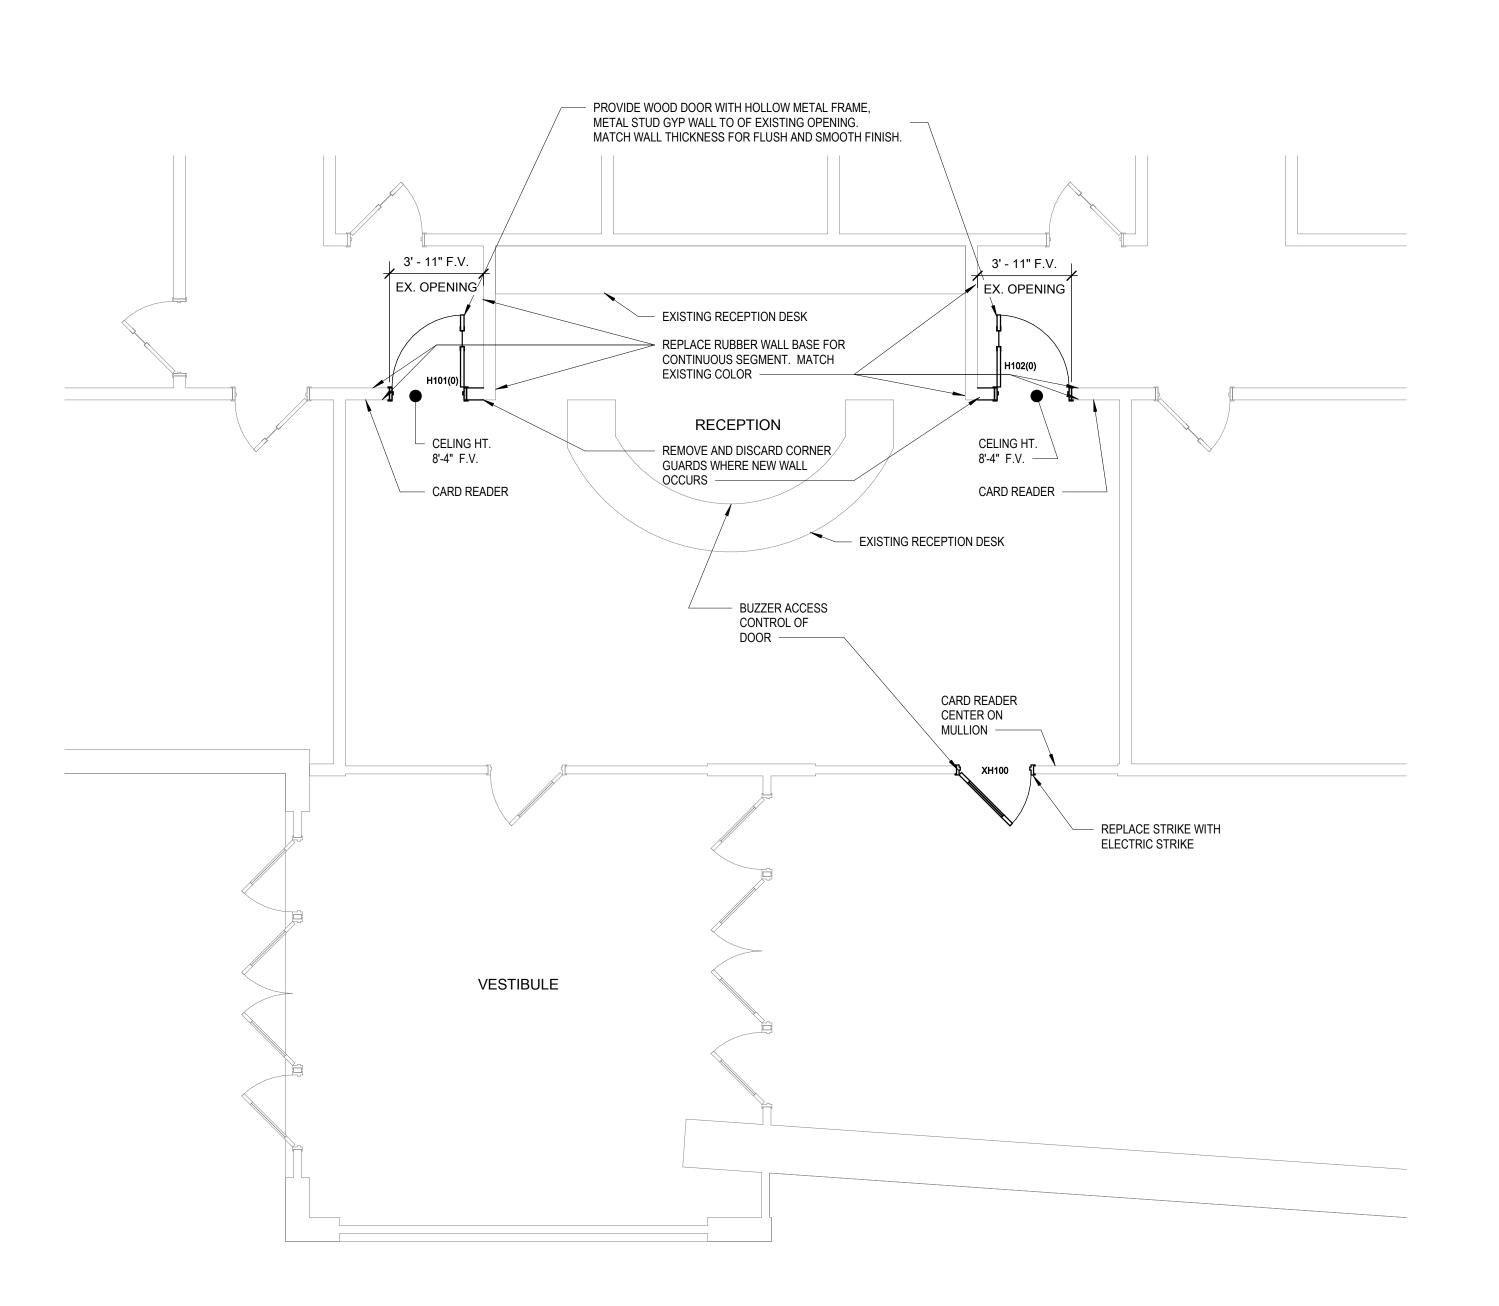
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GENERAL FLOOR PLAN NOTES

A. Dimensions are to face of masonry, concrete and gypsum board and centerline of columns unless noted otherwise.

structural items, etc.

- B. Field verify all dimensions prior to fabrication of any cabinetry, frames,
- C. Provide painted access panels in walls and ceilings at concealed items, such as valves, shock absorbers, controls, switches, etc., and any other items that may require access. It is the Contractor's responsibility to
- determine access panel locations. D. Verify and coordinate all requirements for owner furnished items, prior to performance of any work that is to accommodate and interface with such
- E. All angles are increments of 45 degrees unless noted otherwise.
- F. All frame walls to be Type S01, unless noted otherwise.
- H. Repair all finish surface around door and effected area. Match paint to adjacent wall. Secure any loose flooring effected by door installation.
- I. Mount all card readers 40" A.F.F. to the center of device, U.N.O. Provide card readers with conduits in wall cavity, no surface mounted conduits, U.N.O., or approved by architect.
- J. Reference Electrcial plans for power to Card Readers and Electric Strikes.
- K. All door frames in scope, noted with door tag and ref. door schdule, to have new painted finish to match existing door frames per school. All door finish to match existing doors per school.
- L. Doors shown at 45 degrees are exist doors. See plans for notes were existing doors will require repair/upgrade.



FIRST FLOOR - WALNUT GROVE M.S.

1/4" = 1'-0" REF 2 / A-108

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PROJECT TEAM TX Ed Studio


PROJECT PHASE

Construction Documents SHEET CONTENTS FIRST FLOOR PLAN -

WALNUT GROVE M.S.

SHEET NO.

SITE AERIAL

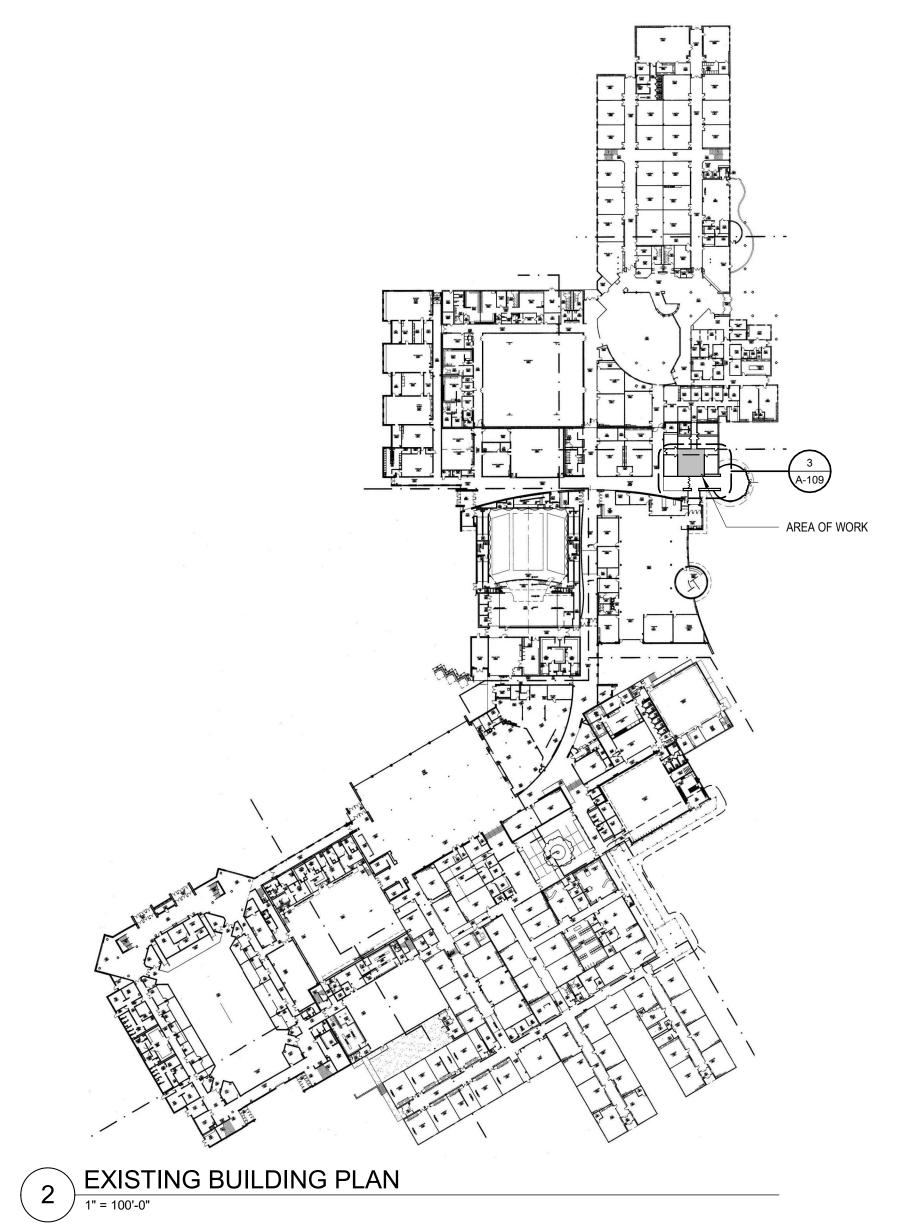

DEMOLITION PLAN GENERAL NOTES

- and items required to be removed.
- B. Where gypsum board is to remain, patch, tape and float portion of wall to match adjacent new finish.
- D. Contractor shall remove and replace any fireproofing or firestopping damage during demolition or new construction to conform to proper rating.
- E. Contractor shall coordinate any shutdown required during demolition with Owner.

- A. Coordinate demolition with new construction. All demolition and repair necessary to accomplish new construction shall be included. Contractor shall remove all existing improvements whether or not specifically indicated on the drawings to facilitate the completion of all required work. Contractors shall visit the site and verify all quantities
- C. Contractor to coordinate demolition so all wiring, conduit, equipment, etc. to remain is not damaged. Certain items may be temporarily removed and replaced later during course of restoration. General Contractor will be required to incorporate this work into their schedule. The systems may include, but are not limited to the following: EMS/controls, electrical power and lighting, data, audiovisual, security, intercom,


CATV, etc. Contractor to tag and loop wire to remain back to control panels, typical.

- F. Contractor to maintain or repair fire and smoke ratings of existing floor, roof and wall assemblies throughout.

GENERAL FLOOR PLAN NOTES

structural items, etc.

- A. Dimensions are to face of masonry, concrete and gypsum board and centerline of columns unless noted otherwise.
- B. Field verify all dimensions prior to fabrication of any cabinetry, frames,
- C. Provide painted access panels in walls and ceilings at concealed items, such as valves, shock absorbers, controls, switches, etc., and any other items that may require access. It is the Contractor's responsibility to determine access panel locations.
- D. Verify and coordinate all requirements for owner furnished items, prior to performance of any work that is to accommodate and interface with such
- E. All angles are increments of 45 degrees unless noted otherwise.
- F. All frame walls to be Type S01, unless noted otherwise.
- H. Repair all finish surface around door and effected area. Match paint to adjacent wall. Secure any loose flooring effected by door installation.
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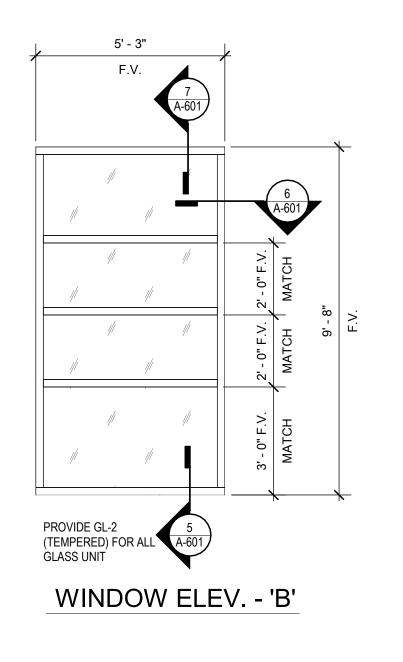
PROJECT TEAM

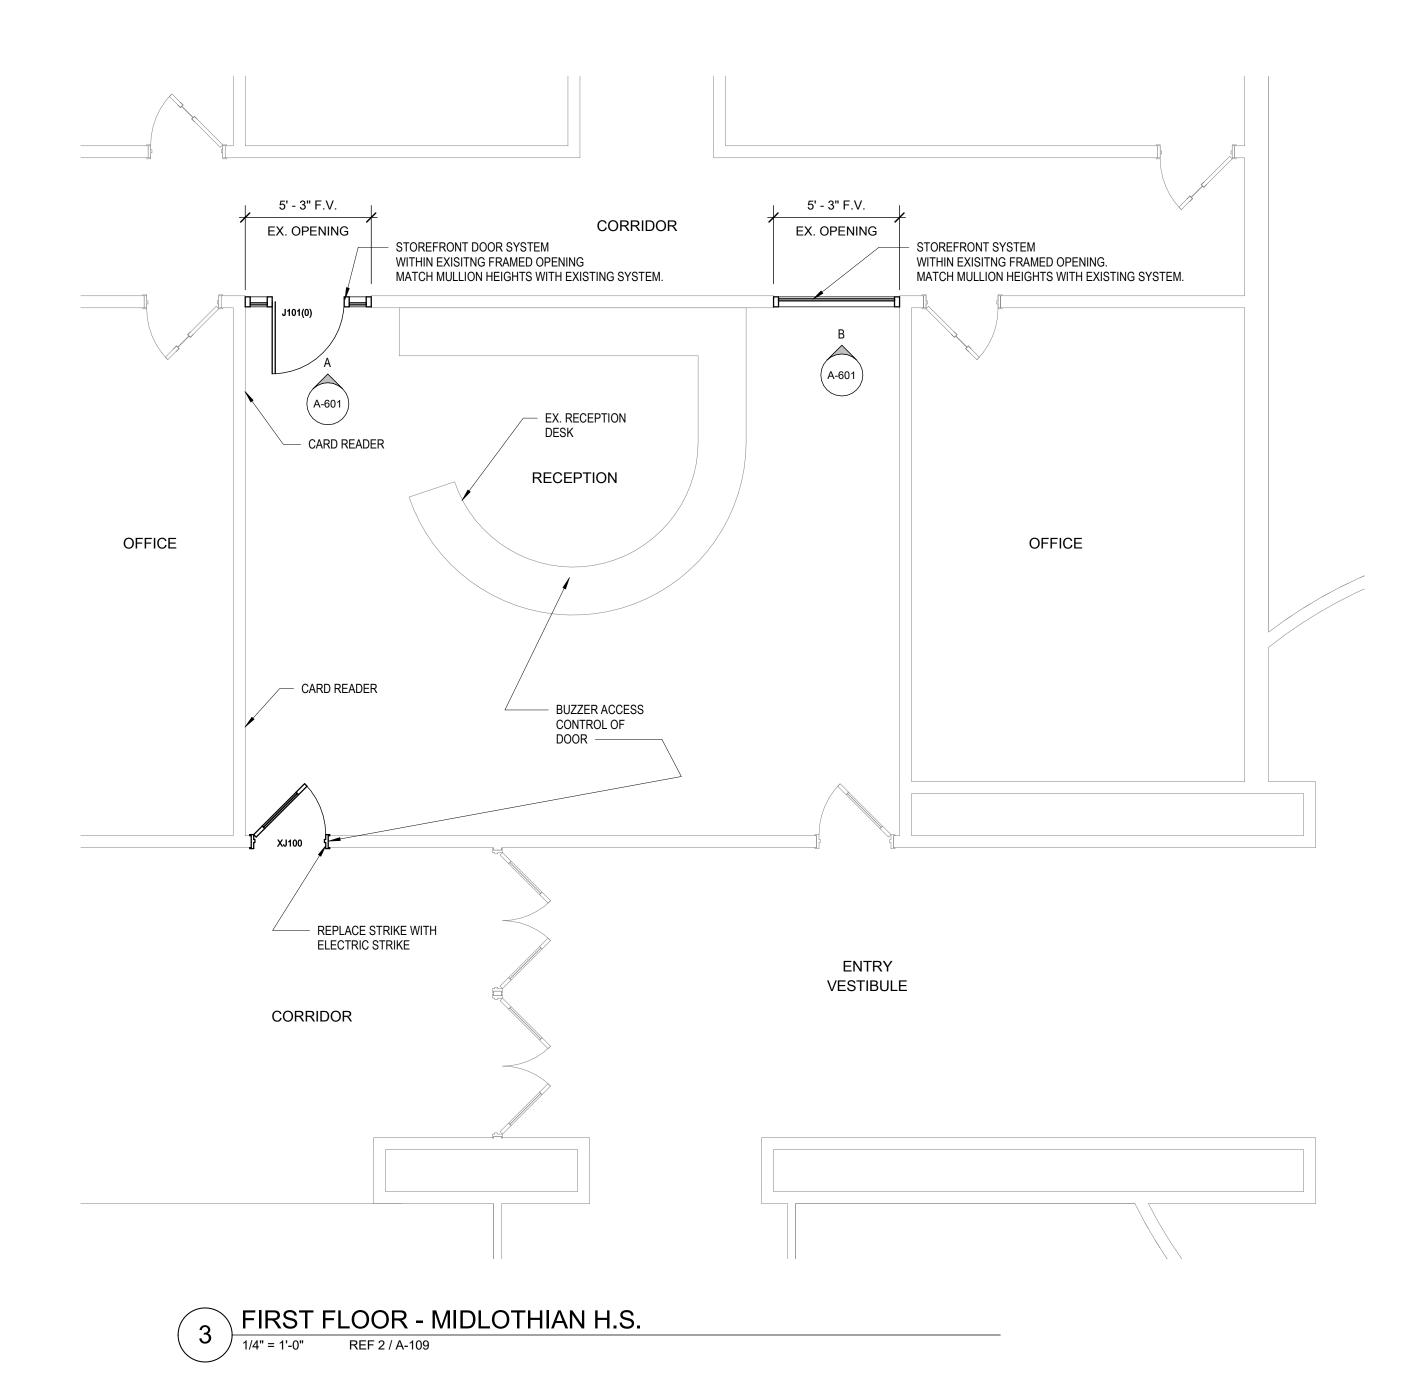TX Ed Studio PROJECT PHASE


Construction Documents

SHEET CONTENTS FIRST FLOOR PLAN -MIDLOTHIAN H.S.

SHEET NO.




						1				_			
Door Size		Door Size		•	Door Frame		9			Details			
Door Number	Width	Height	Thickness Door Type	Door Material	Door Finish	Frame Type	Frame Material	Frame Finish	Fire Rating	Head	Jamb	Threshold	Remarks
A101	6'-0"	7'-0"	1 3/4" G2	ALUM	CLR	FB	ALUM	CLR	0	07/A601	06/A601	05/A601	L.A. MILLS ADMINISTRATION
A102	6'-0"	7'-0"	1 3/4" G2	ALUM	CLR	FB	ALUM	CLR	0	07/A601	06/A601	05/A601	L.A. MILLS ADMINISTRATION
B102	3'-0"	7'-0"	1 3/4" F	WD	WV	FA	HM	PNT	0	01/A601	02/A601	03/A601	BAXTER E.S.
C101	2'-10"	7'-0"	1 3/4" NV	WD	WV	FA	HM	PNT	0	01/A601	02/A601	03/A601	LONGBRANCH E.S.
D101	3'-0"	7'-0"	1 3/4" NV	WD	WV	FA	HM	PNT	0	01/A601	02/A601	03/A601	MILLER E.S.
E101	2'-10"	7'-0"	1 3/4" NV	WD	WV	FA	HM	PNT	0	01/A601	02/A601	03/A601	MT. PEAK E.S.
F101	2'-10"	7'-0"	1 3/4" NV	WD	WV	FA	HM	PNT	0	01/A601	02/A601	03/A601	VITOSKY E.S.
G101	3'-0"	7'-0"	1 3/4" NV	WD	WV	FA	HM	PNT	0	01/A601	02/A601	03/A601	FRANK SEALE M.S.
H101	3'-0"	7'-0"	1 3/4" NV	WD	WV	FA	HM	PNT	0	01/A601	02/A601	03/A601	WALNUT GROVE M.S.
H102	3'-0"	7'-0"	1 3/4" NV	WD	WV	FA	HM	PNT	0	01/A601	02/A601	03/A601	WALNUT GROVE M.S.
J101	3'-0"	7'-0"	1 3/4" G2	ALUM	CLR	FA	ALUM	CLR	0	07/A601	06/A601	05/A601	MIDLOTHIAN HIGH SCHOOL
XB100	3'-0"	8'-0"	1 3/4" G3	WD	HM	EXIST.	EXIST.	EXIST.					BAXTER E.S REPLACE DOOR ACCESS CONTROL ONLY
XB101	3'-0"	7'-0"	1 3/4" F	WD	HM	EXIST.	EXIST.	EXIST.					BAXTER E.S REPLACE DOOR ACCESS CONTROL ONLY - DOOR REPOSITIONED
XC100	3'-0"	7'-0"	1 3/4" F	WD	HM	EXIST.	EXIST.	EXIST.					LONGBRANCH E.S REPLACE DOOR ACCESS CONTROL ONLY
XC102	3'-0"	7'-0"	1 3/4" F	WD	НМ	EXIST.	EXIST.	EXIST.					LONGBRANCH E.S REPLACE DOOR ACCESS CONTROL ONLY
XD100	3'-0"	7'-0"	1 3/4" NV	WD	НМ	EXIST.	EXIST.	EXIST.					MILLER E.S REPLACE DOOR ACCESS CONTROL ONLY
XD102	3'-0"	7'-0"	1 3/4" NV	WD	НМ	EXIST.	EXIST.	EXIST.					MILLER E.S REPLACE DOOR ACCESS CONTROL ONLY
XD103	3'-0"	7'-0"	1 3/4" NV	WD	НМ	EXIST.	EXIST.	EXIST.					MILLER E.S REPLACE DOOR ACCESS CONTROL ONLY
XE100	3'-0"	7'-0"	1 3/4" F	WD	НМ	EXIST.	EXIST.	EXIST.					MT. PEAK E.S REPLACE DOOR ACCESS CONTROL ONLY
XE102	3'-0"	7'-0"	1 3/4" F	WD	НМ	EXIST.	EXIST.	EXIST.					MT. PEAK E.S REPLACE DOOR ACCESS CONTROL ONLY
XF100	3'-0"	7'-0"	1 3/4" F	WD	НМ	EXIST.	EXIST.	EXIST.					VITOVSKY E.S REPLACE DOOR ACCESS CONTROL ONLY
XF102	3'-0"	7'-0"	1 3/4" F	WD	НМ	EXIST.	EXIST.	EXIST.					VITOVSKY E.S REPLACE DOOR ACCESS CONTROL ONLY
XG100	3'-0"	7'-0"	1 3/4" G3	WD	НМ	EXIST.	EXIST.	EXIST.					FRANK SEALE M.S REPLACE DOOR ACCESS CONTROL ONLY
XG101	3'-0"	7'-0"	1 3/4" NV	WD	НМ	EXIST.	EXIST.	EXIST.					FRANK SEALE M.S REPLACE DOOR ACCESS CONTROL ONLY
XH100	3'-0"	7'-0"	1 3/4" G3	WD	НМ	EXIST.	EXIST.	EXIST.					WALNUT GROVE M.S REPLACE DOOR ACCESS CONTROL ONLY
XJ100	3'-0"	7'-0"	1 3/4" G3	WD	НМ	EXIST.	EXIST.	EXIST.					MIDLOTHIAN HIGH SCHOOL - REPLACE DOOR ACCESS CONTROL ONLY

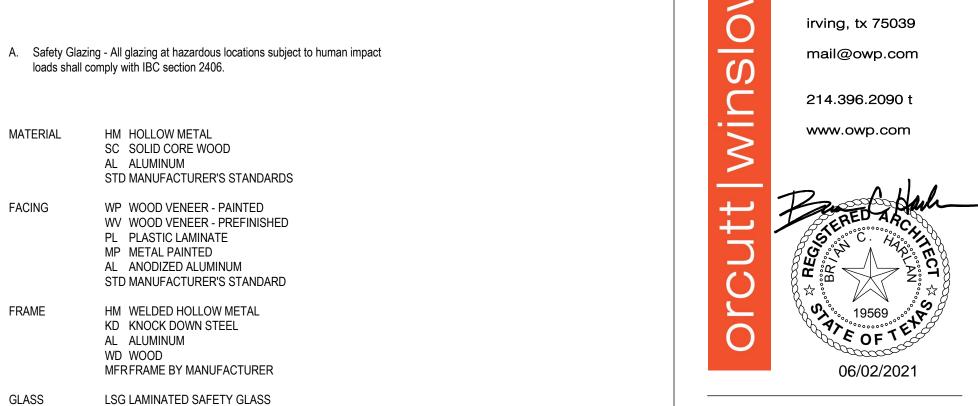


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MR MIRROR


PC POLYCARBONATE

T TEMPERED GLASS FRG FIRE RATED GLASS

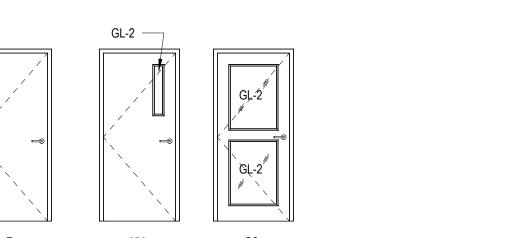20, 45, 60 ASSEMBLY RATING IN MINUTES

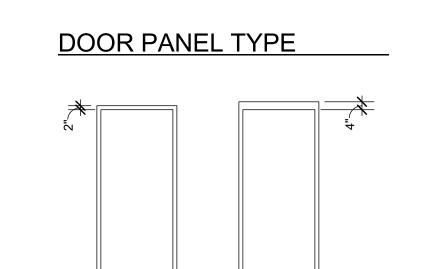HARDWARE H-# HARDWARE SET NUMBER PER SECTION 087100



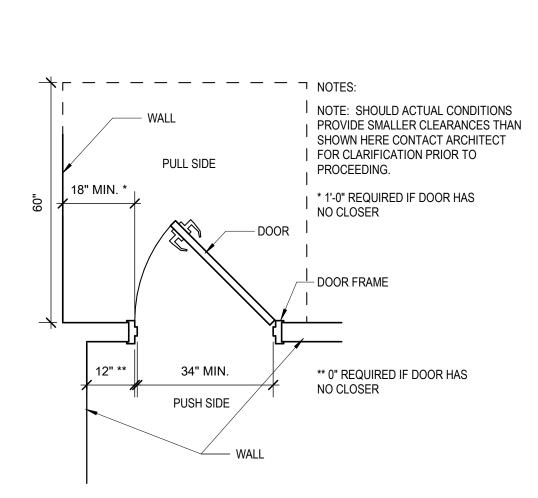


DOOR CLEARANCE


SECTION 08 8100 **GLASS AND GLAZING** Manufacturers Anemostat Mississippi Glass Company Old Castle Pilkington **PPG Industries** Technical Glass Products

1. Float Glass (GL-1): Shall be flat, 1/4 inch thick unless noted otherwise on Drawings, meeting ASTM C1036. Float glass shall be glazed with clean cut edges. Tempered (GL-2):

Glass so indicated and required by federal and local regulations and the authorities having jurisdiction shall be fully tempered conforming to ASTM C 1048, Kind FT (fully tempered), Class 1 (clear). Provide in doors, sidelights and other designated locations. Color: Clear. Thickness: 1/4".

. Install glass types at locations shown on Drawings. Make adjacent glass in same glazed areas consistent in type and thickness unless otherwise noted or directed. Glazing subcontractor shall be responsible for determining locations requiring tempered and/or fire rated glazing to comply with all applicable codes and AHJ.

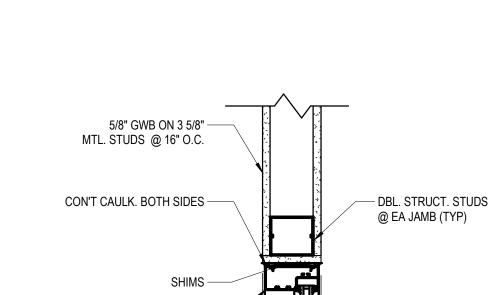

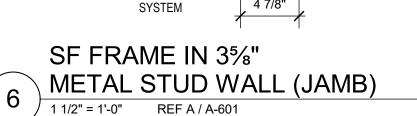

ALUM STOREFRONT —

ALUM STOREFRONT —


CON'T CAULKING,

BOTH SIDES

EXISTING -

FLOOR FINSH

SYSTEM

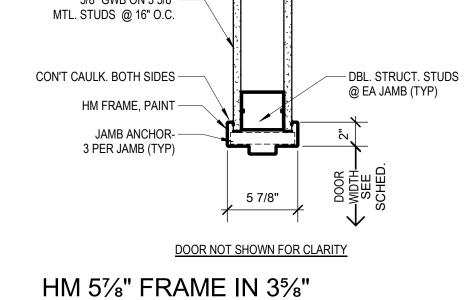

METAL STUD WALL (JAMB)

5 7/8"

— MTL. STUD TRACK

5/8" GWB ON 3 5/8"


MTL. STUDS @ 16" O.C.

CON'T CAULK. BOTH SIDES -

HM FRAME, PAINT


HM 51/8" FRAME IN 35/8"

METAL STUD WALL (HEAD)

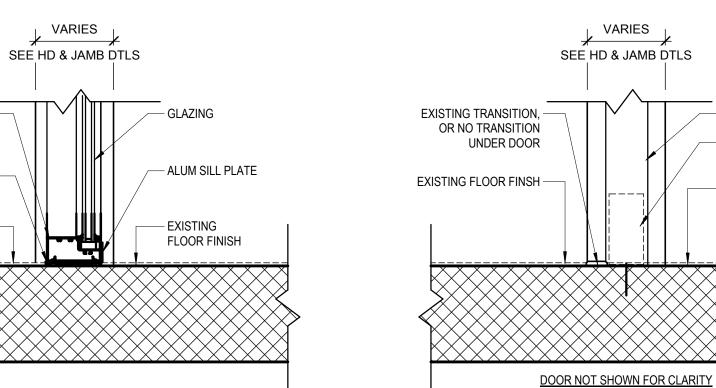





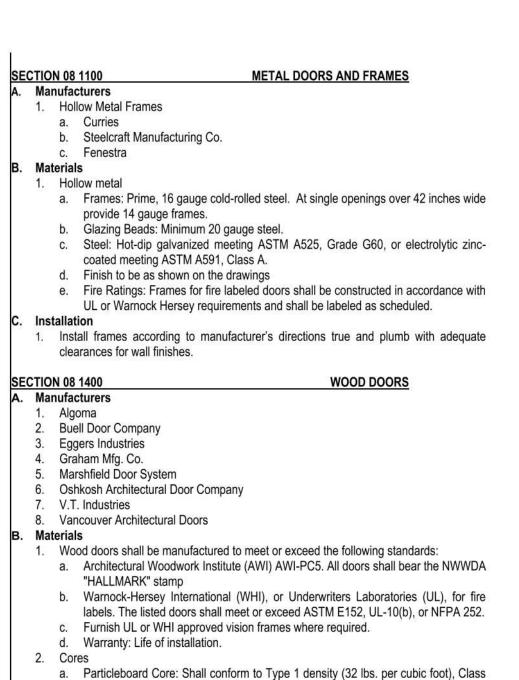

b. Mineral core: asbestos-free noncombustible mineral core proving rating as required

a. Face veneers to be "premium grade"; cut and matching shall be as indicated on

for assembly flush veneered doors, 5-ply minimum, shall

be selected from manufacturer's available sources.

1, commercial standard #236-66.

provided prefinished.

Veneers

functioning.

drawings. Edge banding shall match face veneer. All wood veneer doors shall be b. When plastic laminate faces are specified. laminate shall be .050 standard grade to 1. Doors shall be hung true and plumb with standard bevel and with uniform 3/32 inch clearance at jambs and head, and 1/2 inch bottom clearance unless otherwise required. Wood doors installed on the Project shall operate freely without sticking or binding, without hinge-bound conditions and with hardware installed, properly adjusted and



The following series designations reference systems by Arcadia, Inc. Equal systems by approved manufacturers are acceptable. Interior (non-thermal) Center Glazed Framing System: Aluminum entrances and storefronts framing shall be center glazed

system for 1/4 inch 3/8 inch or 1/2 inch glass as follows. AR450 - 2" x 4 1/2" for 1/4" glass Extruded framing members shall be A-6063-T6 alloy and temper aluminum complying with ASTM B221 alloy G.S. 104-55 having a minimum wall thickness

Provide fasteners for assembling the framing systems of aluminum, stainless

steel, and other materials warranted by the manufacturer to be non-corrosive and compatible with aluminum components, hardware, anchors and other Steel fasteners used in the assembly of the framing system shall be coated with a zinc coating complying with ASTM B633.

Perimeter anchors shall be aluminum or steel of the suitable size and design to

resist applied loading on the framing system: Steel fasteners used in the assembly of the framing system shall be coated with a zinc coating complying with ASTM B633. Glazing gaskets at shall be manufacturer's standard for system specified. Glass shall be as specified in Section 08 8100, Glass Glazing, and installed as

specified herein. Sealant as recommended by system manufacturer.

A. The following series designations reference systems by Arcadia, Inc. Equal systems by approved manufacturers are acceptable. Doors: Manufacturer's standard glazed doors, for manual swing operation. Door Construction 1 3/4" - 2 1/4" overall thickness, with a minimum of 0.125 inch thick, extruded-aluminum tubular rail and stile members.

Mechanically fastened and welded corners. Door Design: WS 512 (Wide Stile) - 5 inch stile) .125

1. All integrated electric and non electric hardware for immediate entrance doors and frames specified under "Finish Hardware" of the specifications shall be furnished and installed by the door and frame manufacturer.

ALUMINUM FINISHES General: Comply with NAAMM's "Metal Finishes Manual for Architectural and Metal Products" for recommendations for applying and designating finishes. Finish designations prefixed by AA comply with the system

established by the Aluminum Association for designating aluminum Class I, Clear Anodic Finish: AA-M12C22A41 (Mechanical Finish: nonspecular as fabricated; Chemical Finish: etched, medium matte; Anodic Coating: Architectural Class I, clear coating 0.018 mm or thicker) complying with AAMA 611.

Comply with manufacturer's instructions and recommendations for installation. Installation shall be completed only by qualified personnel, experienced in this type of Work.

Set units plumb, level, and true to line, without warping or racking of framing members. Provide proper support and anchor securely in place. Comply with the recommended installation requirements for "thermal expansion" in accordance with the framing system manufacturers printed instructions. 1. Separate aluminum and other corrodible metal surfaces from sources of corrosion or electrolytic action at points of contact with other materials. Comply with requirements specified under paragraph "Dissimilar Materials" in the Appendix to American

Architectural Manufacturers Association 101. Head members for butt hinges and offset hung door installations shall

be "solid, one-piece tubular" extruded members only. Drill and tap framing members as required for the installation of doors and apply surface-mounted hardware items. Sill members shall be set in full bed of sealant, or with joint fillers or gaskets to provide weather-tight construction. Install flashings and


end dams in strict compliance with manufacturer's details.

5/8" GWB ON 3 5/8" -MTL. STUDS @ 16" O.C. CON'T CAULK. BOTH SIDES -SHIM — ALUM STOREFRONT — SF FRAME IN 35/8" METAL STUD WALL (HEAD)

1 1/2" = 1'-0" REF A / A-601

5/8" GWB ON 3 5/8"



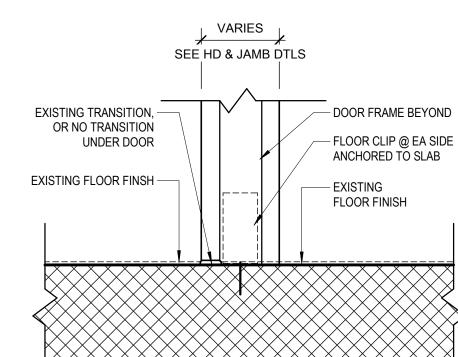

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REVISIONS

DRAWN BY

TX Ed Studio PROJECT PHASE

PROJECT TEAM

Construction Documents

SHEET CONTENTS DOOR & WINDOW SCHEDULES, ELEVATIONS

1. ELECTRICAL CONTRACTOR SHALL PROVIDE ALL CONDUIT AND STANDARD BACKBOXES FOR SYSTEMS SHOWN ON THIS DRAWING IN BASE PROPOSAL.

2. IN ANY EXPOSED AREAS SUCH AS GYMNASIUMS, SHOPS, FIELD HOUSES, JANITORS CLOSETS, OR MECHANICAL/ELECTRICAL ROOMS ALL LOW VOLTAGE CABLING SHALL BE ENCLOSED IN CONDUIT.

3. ALL COMMUNICATIONS CABLING SHALL RUN DOWN THE CORRIDORS AND BRANCH OFF TO EACH CLASSROOM. TRUNKING SHALL BE RAN PRIMARILY PERPENDICULAR TO BUILDING WALLS AND SHALL NOT BE RAN OVER CLASSROOMS.

PROTRUDE BELOW BOTTOM OF STEEL. THE ARCHITECT SHALL APPROVE ALL ROUTING OF ALL EXPOSED ROUGH-INS PRIOR TO PLACEMENT.

4. WHERE NO FINISHED CEILINGS ARE SCHEDULED ALL DEVICES, CONDUIT, AND BACKBOXES SHALL BE INSTALLED UP AGAINST BOTTOM OF DECK AND SHALL NOT

5. ANY SIGNAL, OUTLET OR OTHER DEVICE MOUNTED ON A COLUMN, PILASTER, OR SIMILAR WALL OFFSET SHALL BE CENTERED.

6. COORDINATE MOUNTING HEIGHT OF DEVICES ABOVE MILLWORK WITH ARCHITECTURAL PLANS.

7. VERIFY MARKERBOARD, TACKBOARD, AND DOOR SWING LOCATIONS WITH ARCHITECTURAL PLANS - DO NOT INSTALL DEVICES IN THESE AREAS.

8. COORDINATE EXACT LOCATION OF ALL DEVICES, ETC. INSTALLED IN MOVEABLE FURNITURE WITH ARCHITECT AND OWNER.

9. CONFIRM ALL COMMUNICATIONS DEVICE LOCATIONS WITH ARCHITECT PRIOR TO ROUGH-IN. THE ARCHITECT RESERVES THE RIGHT TO LOCATE DEVICES ANYWHERE WITHIN EACH ROOM AND DETERMINE SURFACE RACEWAY ROUTING IF APPLICABLE.

10. REFER TO SPECIFICATION AND 28 FOR ADDITIONAL INFORMATION.

ELECTRICAL COMMUNICATION PLAN NOTES

- 1 FIELD VERIFY EXACT LOCATION OF EXISTING ACCESS CONTROL PANEL. EXPAND NEW HARDWARE TO EXISTING SYSTEM.
- PROVIDE JUNCTION BOX FOR UNDER COUNTER DOOR RELEASE BUTTON TO DOORS AS INDICATED.

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PROJECT PHASE CONSTRUCTION DOCUMENTS

SHEET CONTENTS ELECTRICAL COMMUNICATIONS FLOOR PLAN - ADMINISTRATION

SHEET NO.

1. ELECTRICAL CONTRACTOR SHALL PROVIDE ALL CONDUIT AND STANDARD BACKBOXES FOR SYSTEMS SHOWN ON THIS DRAWING IN BASE PROPOSAL.

2. IN ANY EXPOSED AREAS SUCH AS GYMNASIUMS, SHOPS, FIELD HOUSES, JANITORS CLOSETS, OR MECHANICAL/ELECTRICAL ROOMS ALL LOW VOLTAGE CABLING SHALL BE ENCLOSED IN CONDUIT.

3. ALL COMMUNICATIONS CABLING SHALL RUN DOWN THE CORRIDORS AND BRANCH OFF TO EACH CLASSROOM. TRUNKING SHALL BE RAN PRIMARILY PERPENDICULAR TO BUILDING WALLS AND SHALL NOT BE RAN OVER CLASSROOMS.

BACKBOXES SHALL BE INSTALLED UP AGAINST BOTTOM OF DECK AND SHALL NOT PROTRUDE BELOW BOTTOM OF STEEL. THE ARCHITECT SHALL APPROVE ALL ROUTING OF ALL EXPOSED ROUGH-INS PRIOR TO PLACEMENT.

4. WHERE NO FINISHED CEILINGS ARE SCHEDULED ALL DEVICES, CONDUIT, AND

5. ANY SIGNAL, OUTLET OR OTHER DEVICE MOUNTED ON A COLUMN, PILASTER, OR SIMILAR WALL OFFSET SHALL BE CENTERED.

6. COORDINATE MOUNTING HEIGHT OF DEVICES ABOVE MILLWORK WITH ARCHITECTURAL PLANS.

7. VERIFY MARKERBOARD, TACKBOARD, AND DOOR SWING LOCATIONS WITH ARCHITECTURAL PLANS - DO NOT INSTALL DEVICES IN THESE AREAS.


8. COORDINATE EXACT LOCATION OF ALL DEVICES, ETC. INSTALLED IN MOVEABLE FURNITURE WITH ARCHITECT AND OWNER.

9. CONFIRM ALL COMMUNICATIONS DEVICE LOCATIONS WITH ARCHITECT PRIOR TO ROUGH-IN. THE ARCHITECT RESERVES THE RIGHT TO LOCATE DEVICES ANYWHERE WITHIN EACH ROOM AND DETERMINE SURFACE RACEWAY ROUTING IF APPLICABLE.

10. REFER TO SPECIFICATION AND 28 FOR ADDITIONAL INFORMATION.

ELECTRICAL COMMUNICATION PLAN NOTES

- 1 FIELD VERIFY EXACT LOCATION OF EXISTING ACCESS CONTROL PANEL. EXPAND NEW HARDWARE TO EXISTING SYSTEM.
- PROVIDE JUNCTION BOX FOR UNDER COUNTER DOOR RELEASE BUTTON TO DOOR AS INDICATED.

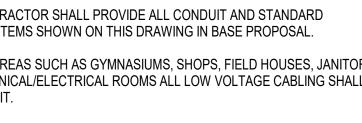



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GENERAL NOTES

1. ELECTRICAL CONTRACTOR SHALL PROVIDE ALL CONDUIT AND STANDARD

ENCLOSED IN CONDUIT.

3. ALL COMMUNICATIONS CABLING SHALL RUN DOWN THE CORRIDORS AND BRANCH OFF TO EACH CLASSROOM. TRUNKING SHALL BE RAN PRIMARILY PERPENDICULAR TO BUILDING WALLS AND SHALL NOT BE RAN OVER CLASSROOMS.

BACKBOXES SHALL BE INSTALLED UP AGAINST BOTTOM OF DECK AND SHALL NOT PROTRUDE BELOW BOTTOM OF STEEL. THE ARCHITECT SHALL APPROVE ALL ROUTING OF ALL EXPOSED ROUGH-INS PRIOR TO PLACEMENT.

4. WHERE NO FINISHED CEILINGS ARE SCHEDULED ALL DEVICES, CONDUIT, AND

FURNITURE WITH ARCHITECT AND OWNER. 9. CONFIRM ALL COMMUNICATIONS DEVICE LOCATIONS WITH ARCHITECT PRIOR TO

ROUGH-IN. THE ARCHITECT RESERVES THE RIGHT TO LOCATE DEVICES ANYWHERE

PLAN NOTES

- NEW HARDWARE TO EXISTING SYSTEM.
- PROVIDE JUNCTION BOX FOR UNDER COUNTER DOOR RELEASE BUTTON TO DOOR

ELECTRICAL COMMUNICATIONS

BACKBOXES FOR SYSTEMS SHOWN ON THIS DRAWING IN BASE PROPOSAL. 2. IN ANY EXPOSED AREAS SUCH AS GYMNASIUMS, SHOPS, FIELD HOUSES, JANITORS CLOSETS, OR MECHANICAL/ELECTRICAL ROOMS ALL LOW VOLTAGE CABLING SHALL BE

5. ANY SIGNAL, OUTLET OR OTHER DEVICE MOUNTED ON A COLUMN, PILASTER, OR

SIMILAR WALL OFFSET SHALL BE CENTERED.

6. COORDINATE MOUNTING HEIGHT OF DEVICES ABOVE MILLWORK WITH ARCHITECTURAL PLANS.

7. VERIFY MARKERBOARD, TACKBOARD, AND DOOR SWING LOCATIONS WITH ARCHITECTURAL PLANS - DO NOT INSTALL DEVICES IN THESE AREAS.

8. COORDINATE EXACT LOCATION OF ALL DEVICES, ETC. INSTALLED IN MOVEABLE

WITHIN EACH ROOM AND DETERMINE SURFACE RACEWAY ROUTING IF APPLICABLE. 10. REFER TO SPECIFICATION AND 28 FOR ADDITIONAL INFORMATION.

ELECTRICAL COMMUNICATION

- 1 FIELD VERIFY EXACT LOCATION OF EXISTING ACCESS CONTROL PANEL. EXPAND
- AS INDICATED.

PROJECT TEAM DRAWN BY TX Ed Studio PROJECT PHASE CONSTRUCTION DOCUMENTS

> SHEET CONTENTS ELECTRICAL COMMUNICATIONS FLOOR PLAN - LONGBRANCH SHEET NO.

469-856-5000 T rola_facel@misd.gov

OWP PROJECT NO. DATE OF ISSUE

06.02.2021

EMA Engineering & Consulting
Tyler | Austin | Houston | DFW | El Paso
TBPE Firm Registration No. F-893
www.EMAengineer.com
Phone: 1.800.933.0538 SUBMISSION OF BID WILL BE CONSIDERED ACKNOWLEDGMENT THAT THE CONTRACTOR HAS VISITED THE SITE AND HAS VERIFIED ALL EXISTING JOB

CONDITIONS AND INCLUDED ANY NECESSARY MODIFICATION TO EXISTING AND NEW WORK REQUIRED FOR INSTALLATION OF A COMPLETE AND WORKING

ENTRY VESTIBULE 158 1 ELECTRICAL COMMUNICATION FLOOR PLAN - LONGBRANCH 1/8" = 1'-0"

CONFERENCE 140 VESTIBULE 138 CORRIDOR 147

ELECTRICAL COMMUNICATIONS GENERAL NOTES

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PROJECT TEAM DRAWN BY TX Ed Studio

PROJECT PHASE CONSTRUCTION DOCUMENTS

SHEET CONTENTS ELECTRICAL COMMUNICATIONS FLOOR

PLAN - MILLER ES SHEET NO.

1. ELECTRICAL CONTRACTOR SHALL PROVIDE ALL CONDUIT AND STANDARD BACKBOXES FOR SYSTEMS SHOWN ON THIS DRAWING IN BASE PROPOSAL.

2. IN ANY EXPOSED AREAS SUCH AS GYMNASIUMS, SHOPS, FIELD HOUSES, JANITORS CLOSETS, OR MECHANICAL/ELECTRICAL ROOMS ALL LOW VOLTAGE CABLING SHALL BE ENCLOSED IN CONDUIT.

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ELECTRICAL COMMUNICATION PLAN NOTES

- 1 FIELD VERIFY EXACT LOCATION OF EXISTING ACCESS CONTROL PANEL. EXPAND NEW HARDWARE TO EXISTING SYSTEM.
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PLAN - MT PEAK SHEET NO.

COMMUNICATIONS FLOOR

CONSTRUCTION DOCUMENTS

SHEET CONTENTS

ELECTRICAL

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OWP PROJECT NO. DATE OF ISSUE

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PROJECT TEAM DRAWN BY TX Ed Studio

PROJECT PHASE CONSTRUCTION DOCUMENTS

SHEET CONTENTS ELECTRICAL

COMMUNICATIONS FLOOR PLAN - VITOVKSY ES SHEET NO.

1 ELECTRICAL COMMUNICATION FLOOR PLAN - SEALE MS 1/8" = 1'-0"

ELECTRICAL COMMUNICATIONS GENERAL NOTES

1. ELECTRICAL CONTRACTOR SHALL PROVIDE ALL CONDUIT AND STANDARD BACKBOXES FOR SYSTEMS SHOWN ON THIS DRAWING IN BASE PROPOSAL.

2. IN ANY EXPOSED AREAS SUCH AS GYMNASIUMS, SHOPS, FIELD HOUSES, JANITORS CLOSETS, OR MECHANICAL/ELECTRICAL ROOMS ALL LOW VOLTAGE CABLING SHALL BE ENCLOSED IN CONDUIT.

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7. VERIFY MARKERBOARD, TACKBOARD, AND DOOR SWING LOCATIONS WITH ARCHITECTURAL PLANS - DO NOT INSTALL DEVICES IN THESE AREAS.


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10. REFER TO SPECIFICATION AND 28 FOR ADDITIONAL INFORMATION.

ELECTRICAL COMMUNICATION PLAN NOTES

- 1 FIELD VERIFY EXACT LOCATION OF EXISTING ACCESS CONTROL PANEL. EXPAND NEW HARDWARE TO EXISTING SYSTEM.
- PROVIDE JUNCTION BOX FOR UNDER COUNTER DOOR RELEASE BUTTON TO DOOR AS INDICATED.



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OWP PROJECT NO. DATE OF ISSUE 06.02.2021
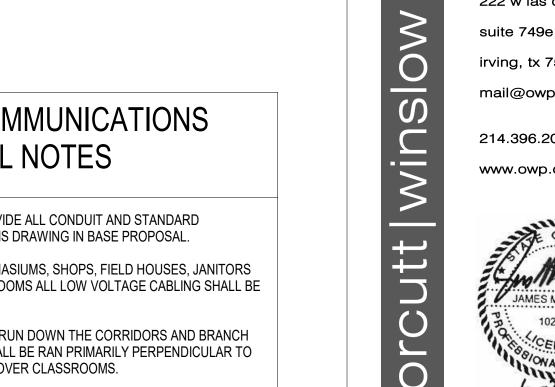
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PROJECT TEAM DRAWN BY

TX Ed Studio

SHEET NO.

PROJECT PHASE CONSTRUCTION DOCUMENTS

SHEET CONTENTS ELECTRICAL COMMUNICATIONS FLOOR PLAN - SEALE MS

RECEPTION 118 VESTIBULE 117

1 ELECTRICAL COMMUNICATION FLOOR PLAN - WALNUT GROVE 1/8" = 1'-0"

ELECTRICAL COMMUNICATIONS GENERAL NOTES

1. ELECTRICAL CONTRACTOR SHALL PROVIDE ALL CONDUIT AND STANDARD BACKBOXES FOR SYSTEMS SHOWN ON THIS DRAWING IN BASE PROPOSAL.

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PROJECT TEAM DRAWN BY

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PROJECT PHASE CONSTRUCTION DOCUMENTS

SHEET CONTENTS ELECTRICAL COMMUNICATIONS FLOOR

PLAN - WALNUT GROVE SHEET NO.

1. ELECTRICAL CONTRACTOR SHALL PROVIDE ALL CONDUIT AND STANDARD BACKBOXES FOR SYSTEMS SHOWN ON THIS DRAWING IN BASE PROPOSAL.

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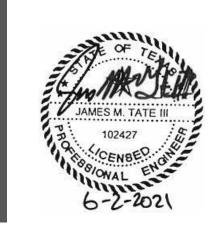
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SHEET CONTENTS ELECTRICAL COMMUNICATIONS FLOOR PLAN - MIDLOTHIAN HS

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PROJECT TEAM DRAWN BY

TX Ed Studio

PROJECT PHASE

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ELECTRICAL COMMUNICATIONS DETAILS & SYMBOLS SHEET NO.

